Drawing Index

These sheets are a document set and should not be separated. Electrical information and references are contained on all sheets.

SITE READINESS

C1

EQUIPMENT LAYOUT

A1

(Equipment locations, heat loads, component weights, environmental specs)

STRUCTURAL LAYOUT

S1

(Structural support/mounting locations for floor/wall/ceiling, wall support elevations)

STRUCTURAL DETAILS

S2

(Floor and Ceiling loading information)
ELECTRICAL LAYOUT

E

(Contractor supplied wiring, interconnect methods, junction point locations and descriptions)

ELECTRICAL SPECIFICATIONS

(Maximum wiring run lengths, interconnect diagram, system power specifications)

ELECTRICAL DETAILS

E3

EQUIPMENT DETAILS

D1 THRU D2

These drawings indicate the placement and interconnection of the listed equipment components. These drawings are not construction or site preparation drawings. Customer remains ultimately responsible for preparing the site to accommodate the operation of such equipment in compliance with GE Healthcare's written specifications and all applicable federal, state, and/or local requirements.

* REQUIRED REFERENCE *

Discovery PET-CT 600

Pre Installation Manual

5266541-1EN

A mandatory component of this drawing set is the GE Healthcare Pre Installation manual. Failure to reference the Pre Installation manual will result in incomplete documentation required for site design and preparation.

Pre Installation documents for GE Healthcare products can be accessed on the web at:

www.gehealthcare.com/siteplanning

GE Healthcare



PET-CT Site Planning



Customer Site Readiness Requirements

- Any deviation from these drawings must be communicated in writing to and reviewed by your local GE Healthcare Installation Project Manager prior to making changes.
- Make arrangements for any rigging, special handling, or facility modifications that must be made to deliver the equipment to the installation site. If desired, your local GE Healthcare Installation Project Manager can supply a reference list of rigging contractors.
- New construction requires the following; 1. Secure area for equipment,
 2. Power for drills and other test equipment,
 3. Capability for image analysis,
 4. Restrooms.
- Provide for refuse removal and disposal (e.g. crates, cartons, packing)
- Contact a radiation physicist or consultant to specify radiation containment requirements.

GE Equipment Delivery Requirements

The items on the GE Healthcare Site Readiness Checklist are REQUIRED to facilitate equipment delivery to the IS site. Equipment will not be delivered if these requirements are not satisfied.

| | Before using this document ensure you have the latest R | ev from M | <u>yWorksh</u> | op on DOC | <u>0422752</u> | |
|----------------------------|--|------------------------------|--------------------------|-------------------------|--|--|
| | | Customer: | | | | |
| GEHC PMI : FE / Installer: | | | | | | |
| | The customer is responsible for proper site preparation regardless of a | | neasurem | ents/inspec | ions/assessments. | |
| | Inspection Date: GEHC Minimum Requirements | Storage Is item ready? | PMI Is item ready? | FE Is item ready? | Comments If "N", enter comments or action plan | |
| 1 | MR Magnet Delivery Requirements: Ensure cryogen venting system is available for magnet connection as defined by GEHC Pre-Installation Manual (PIM) requirements, exhaust fan system is installed and operational, 480V power, and chilled water supply is available 24x7 that meets system cooling requirements. External connectivity is available for magnet monitoring and phone service is available during delivery. Surface mount vibromat installed where required. Magnet room final flooring is in place. | | | | | |
| 2 | MR RF Screen Room Requirements: RF Screen Room is tested with copy of Test Report, emailed to ISAdminCOEMB@ge.com, that it is compliant with GEHC specifications. Dock Bolt and magnet anchors (if applicable) installed using 2 part anchor. For HDx systems, blower box mount bolts installed by RF vendor using 2 part anchors | | | | | |
| 3 | State Regulatory Requirements: Facility registration number provided for states of Ill, KY, HI, RI, SC, TX. X-ray shielding plan and state acknowledgment letter provided to installer for AR, DC, NC, SC, CO & WA. Site Drawing Requirements: Final version of equipment network and antenna, installation drawings (including red lined versions) verified to match actual room and has been provided to installer. | | | | | |
| 4 | Surface Penetration Requirements: Customer/Contractor scheduled to provide required drilling or autting into floors, ceilings, and walls; OR surface penetration permit available and posted in the room when GEHC will perform the work. | | | | | |
| | Pre-Delivery Route Requirements: The equipment delivery route from the truck to the final destination within the facility has been reviewed with all key stakeholders to safely meet the minimum requirements for equipment access, and all communications/notifications have occurred. Arrangements have been made for special handling (elevator, rigging, floor protection, fork lift, rollback truck, etc). | | | | | |
| | Finished Room Requirements: Rooms that will contain equipment, including storage areas not in scan suite, are dust free. Provisions taken to maintain a dust free room. Precautions must be taken to prevent dust from entering rooms containing equipment when construction is incomplete in adjacent areas. All walls primed (final coat not needed on Day 1). Shielding, doors, and windows are to be installed. No contractor work being done during or after the installation that will cause dust in the installation areas or potential equipment damage. Room security to prevent unauthorized access and theft has been discussed with customer. The customer is aware of these security issues, implications and responsibility. For Storage: Room must meet PIM requirements for storage. | | | | | |
| 7 | Electrical Requirements: Lockable (LOTO) Main Disconnect Panel (MDP) is installed per GE guidelines and system power is available. Conduits, electrical cable ducting/dividers/cable trays, and access flooring is installed in proper location and height. Surface floor duct and load-side wires can be installed at time of system installation. Validate outlet location and requirements meet specifications for device/equipment. | | | | | |
| 8 | HVAC Requirements: The HVAC/Chilled Water systems designed to maintain the environment per spec/PIM is at running state and appears to provide the desired environmental conditions including location of vents, temperature and humidity for system operation. | | | | | |
| 9 | Flooring Requirements: Floor is dean and prepared for final floor covering. Floor levelness/flatness is measured and within tolerance, and there are no visible defects per GEHC specifications. Confirm customer anchoring plan aligns with designed floor thickness. Final flooring installed where required for network racks. | | | | | |
| 0 | Ceiling Requirements: Unistrut (or equivalent) location, levelness and spacing is measured (or vendor confirmed) and consistent with the requirement of the installation drawings. Ensure unistrut and rails are not used as mounting surfaces. Ceiling grid is installed. Permanent lighting is installed and operational. HVAC diffusers are installed and connected to ductwork. Ceiling tiles installed per PMI discretion. | | | | | |

E Healthcare

Healthcare P

TITLE: SITE READINESS

TYPE: DISCOVERY PET/CT 600

S SUBMITTED TO SUGGEST LOCATION OF GE HEALTHCARE EQUIPME
ATED APPARATUS, ELECTRICAL WIRING DETAILS AND ROOM ARRANGE
GO THIS PLAN, EVERY EFFORT HAS BEEN MADE TO CONFORM DETAIL

OUT TO BE INSTALLED TO BE INSTALLED.

12-18F TYPICAL LAYOUT

| PROJECT | REVISION |
|-----------|-----------|
| 12-18f | 08 |
| DATE: | 06.Jun.16 |
| DRAWN BY: | DMH |
| CHECKED B | Y: REK |
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SCALE: 1/4" = 1'-0" EQUIPMENT LAYOUT

RECOMMENDED CEILING HEIGHT = 9'-0"

This equipment layout indicates the placement and interconnection of the indicated equipment components. There may be federal, state, and/or local requirements that could impact the placement of these components. It remains the Customer's responsibility for ensuring the site and final equipment placement complies with all applicable federal, state, and/or local requirements.

14'-0"

[4.27M]

7'-0"

[2.13M]

9

CONTROL

14'-0"

[4.27M]

ROOM

IMPORTANT CUSTOMER READINESS ALERT:

THIS EQUIPMENT INVOLVES THE USE OF RADIOACTIVE ISOTOPES, INCLUDING THOSE SOURCES NECESSARY FOR EQUIPMENT CALIBRATION. APPROPRIATE REGULATORY COMPLIANCE AND LICENSING MUST BE ARRANGED BY THE CUSTOMER EARLY IN THE PLANNING PROCESS AND THEN DEMONSTRATED/AVAILABLE FOR EQUIPMENT INSTALLATION.

NOTE: DELIVERY PATH DOWN CORRIDORS FOR GANTRY'S AND TABLE MUST BE EVALUATED PRIOR TO CONSTRUCTION, AS 90 DEGREE TURNS REQUIRE SPECIFIC CORRIDOR WIDTH.

ANCILLARY ITEMS

CUSTOMER/CONTRACTOR SUPPLIED AND INSTALLED ITEMS

ITEM DESCRIPTION
(* INDICATES EXISTING)

60 X-RAY ON WARNING LIGHT - AVAILABLE FROM GE SUPPLY CALL: 800-200-9760 GE CAT. NO. WXIABWW-OF-XIU

61 MINIMUM DOOR OPENING FOR EQUIPMENT DELIVERY IS 42 IN. W x 71 IN. H [1067mm x 1803mm], CONTINGENT ON A 96 IN. [2438mm] CORRIDOR WIDTH

DOOR LIMIT SWITCH
(REQUIRED IN SOUTH CAROLINA, OTHERWISE NEEDED ONLY IF REQUIRED BY STATE/LOCAL CODES)

COUNTER TOP FOR EQUIPMENT-MINIMUM DEPTH 24 in.
OR ADDITIONAL SHELVING MAY BE REQUIRED
PROVIDE GROMMETED OPENINGS AS REQUIRED TO ROUTE
INTERCONNECT CABLES TO RACEWAY BELOW COUNTERTOP.

64 LEAD GLASS WINDOW

THE FOLLOWING ITEMS ARE AVAILABLE FROM GE HEALTHCARE TECHNOLOGIES. CONTACT YOUR LOCAL GE HEALTHCARE SERVICE REPRESENTATIVE FOR PRICING AND AVAILABILITY.

90 E4502RL WARNING LIGHT CONTROL
OR EQUIVALENT MAX 24V CONTROLLER.

MAIN DISCONNECT CONTROL GEMS CAT.NO. E4502AB 90 lbs., SEE DETAIL R4502AD. (IF A UPS IS NOT OR WILL NOT BE ORDERED, THE E4502AD CAN BE USED.)

GENERAL SPECIFICATIONS

- THE REQUIRED CEILING HEIGHT INDICATED ON THESE PLANS IS TO ENSURE EQUIPMENT FUNCTION IS NOT INHIBITED. CONSULT WITH YOUR LOCAL GEHC IS SPECIALIST REGARDING ACCEPTABILITY OF OTHER CEILING HEIGHTS.
- O CHECK ALL DOOR OPENINGS AND HALLWAYS FROM DELIVERY LOCATION TO WHERE EQUIPMENT IS TO BE INSTALLED TO ENSURE THE ROUTE PHYSICALLY AND STRUCTURALLY WILL ACCOMODATE THE EQUIPMENT AS SHIPPED.
- o RADIATION PROTECTION REQUIREMENTS ARE NOT INDICATED ON THIS PLAN. WHERE NEEDED PER NATIONAL OR LOCAL CODE THEY SHALL BE SPECIFIED BY A QUALIFIED RADIOLOGICAL PHYSICIST.
- THE DEVELOPMENT OF THE EQUIPMENT LAYOUT, ROOM DIMENSIONS, MECHANICAL AND ELECTRICAL SUGGESTIONS IS PREDICATED UPON THE BEST INFORMATION OBTAINABLE FROM THE SITE, COUPLED WITH THE CUSTOMER'S KNOWN DESIRES. ARCHITECTURAL OR ELECTRICAL CHANGES INCLUDING RELOCATION OF EQUIPMENT ILLUSTRATED ON THIS DRAWING IS ALLOWED ONLY WITH NOTIFICATION, IN WRITING, AND REVIEW BY GEHC SERVICE DEPARTMENT. EQUIPMENT OPERATION, SERVICEABILITY, AND RESTRICTING CABLE LENGTHS, ETC., MAKE THIS ESSENTIAL FOR A PROPER IS. GEHC RESERVES THE RIGHT TO MAKE ON THE JOB CHANGES BECAUSE OF CUSTOMER REQUIREMENTS AND/OR OBSTACLES IN CONSTRUCTION, ETC..
- ALL WORK TO BE IN COMPLIANCE WITH NATIONAL AND LOCAL BUILDING SAFETY CODES.
- DIMENSIONS ARE TO FINISHED SURFACES OF ROOM

SITE ENVIRONMENT SPECIFICATIONS

- o AMBIENT OPERATING TEMPERATURE: 64° F TO 79° F, (18° C TO 26° C)
- o HUMIDITY: 30 TO 60 PERCENT NON-CONDENSING, STATIC CHARGES ASSOCIATED WITH LOWER HUMIDITY LEVELS MAY INTERFERE WITH SYSTEM OPERATION.
- o ALTITUDE: NOT TO EXCEED 7,875 FT. (2400M) ABOVE SEA LEVEL.
- O DO NOT RESTRICT THE AIR INTAKE OR AIR EXHAUST OF THE SYSTEM COMPONENTS.
- O ENVIRONMENTAL CONDITIONS LISTED ABOVE MUST BE MAINTAINED AT ALL TIMES INCLUDING FOR EXAMPLE OVERNIGHT, WEEKENDS, AND HOLIDAYS.
- BACKGROUND RADIATION SHOULD BE KEPT TO A MINIMUM. RADIOACTIVE SOURCES MUST BE KEPT IN SHIELDED CONTAINERS AND THE EXAMINATION ROOM SHIELDED FROM EXTERNAL SOURCES.
- DO NOT PLACE PET EQUIPMENT NEAR REGISTERS, WINDOWS OR OTHER COMPONENTS THAT COULD AFFECT TEMPERATURE LEVEL CHANGES IN THE PET EQUIPMENT VICINITY.

MAGNETIC INTERFERENCE SPECIFICATIONS

SCANNER MUST BE LOCATED IN AMBIENT STATIC MAGNETIC FIELDS OF LESS THAN 1.0 GAUSS TO GUARANTEE SPECIFIED IMAGING PERFORMANCE.

COMPUTER EQUIPMENT MUST BE LOCATED IN AMBIENT STATIC MAGNETIC FIELDS OF LESS THAN 10 GAUSS TO GUARANTEE DATA INTEGRITY.

DIAGNOSTIC CONSOLE MUST BE LOCATED IN AMBIENT STATIC MAGNETIC FIELDS OF LESS THAN 1 GAUSS TO OBTAIN SPECIFIED GEOMETRIC LINEARITY.

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ET TITLE: EQUIPMENT LAYOUT

Y TYPE: DISCOVERY PET/CT 600

IS SUBMITTED TO SUGGEST LOCATION OF GE HEALTHCARE EQUIPMEN

SIATED APPARATUS, ELECTRICAL WIRING DETAILS AND ROOM ARRANGE
RING THIS PLAN, EVERY EFFORT HAS BEEN MADE TO CONFORM DETAIL

EQUIPMENT EXPECTED TO BE INSTALLED. IT IS NOT TO BE USED

INSTRUCTION PURPOSES, HOWEVER, AND THE COMPANY CANNOT ACC

12-18F Typical layout


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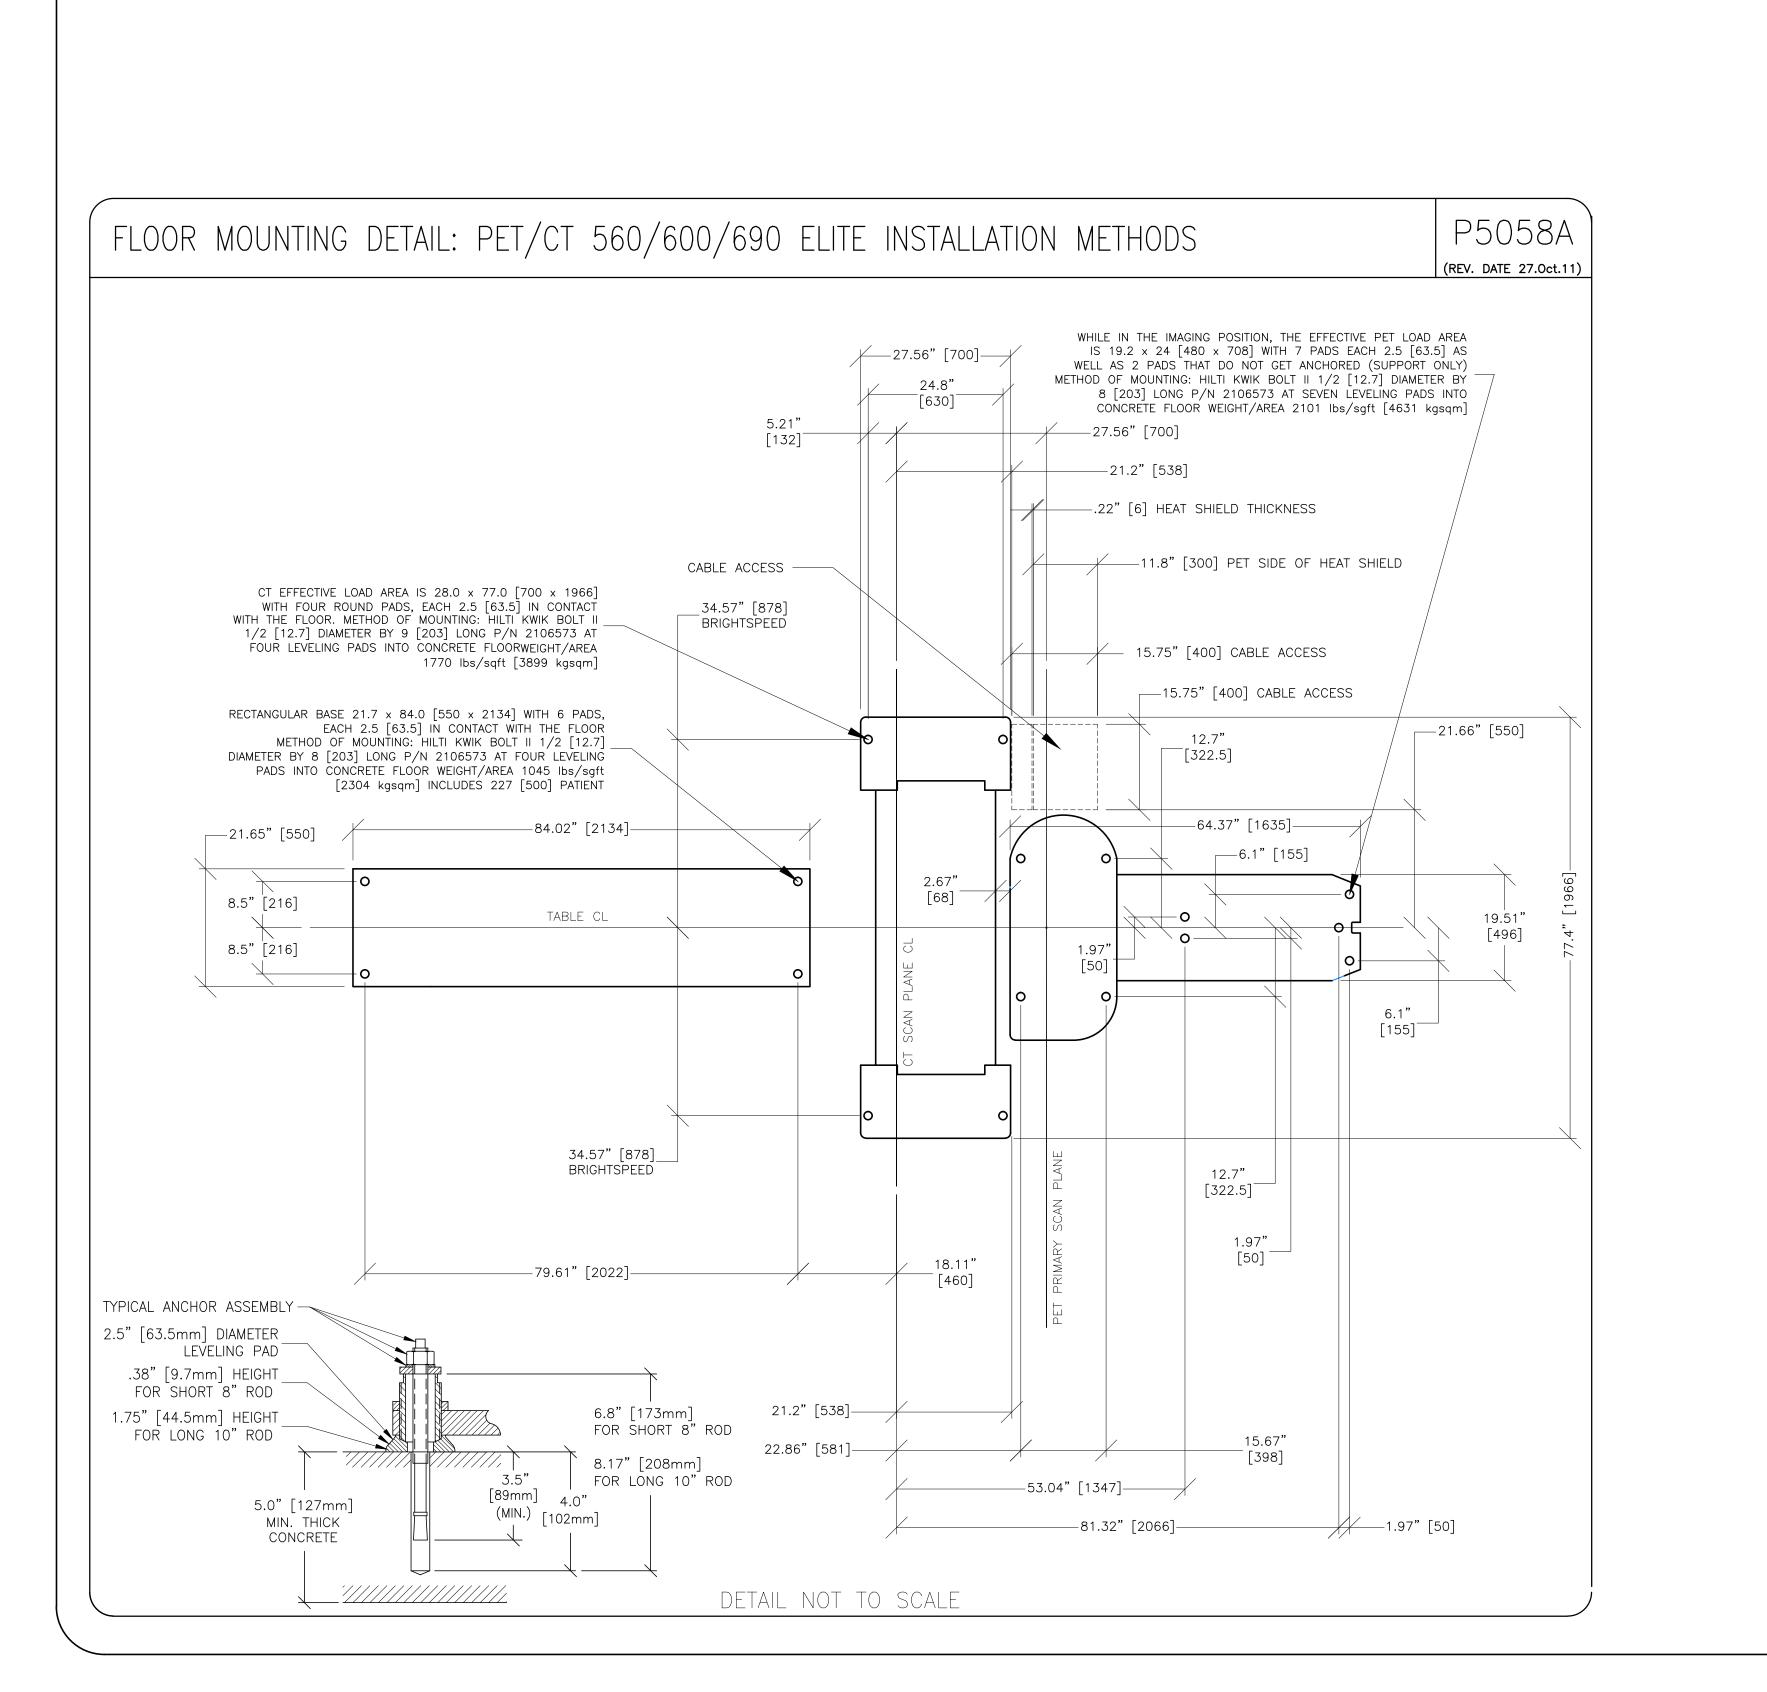
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REVISION HISTORY:

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SHEET A





DETAILS T/CT 600

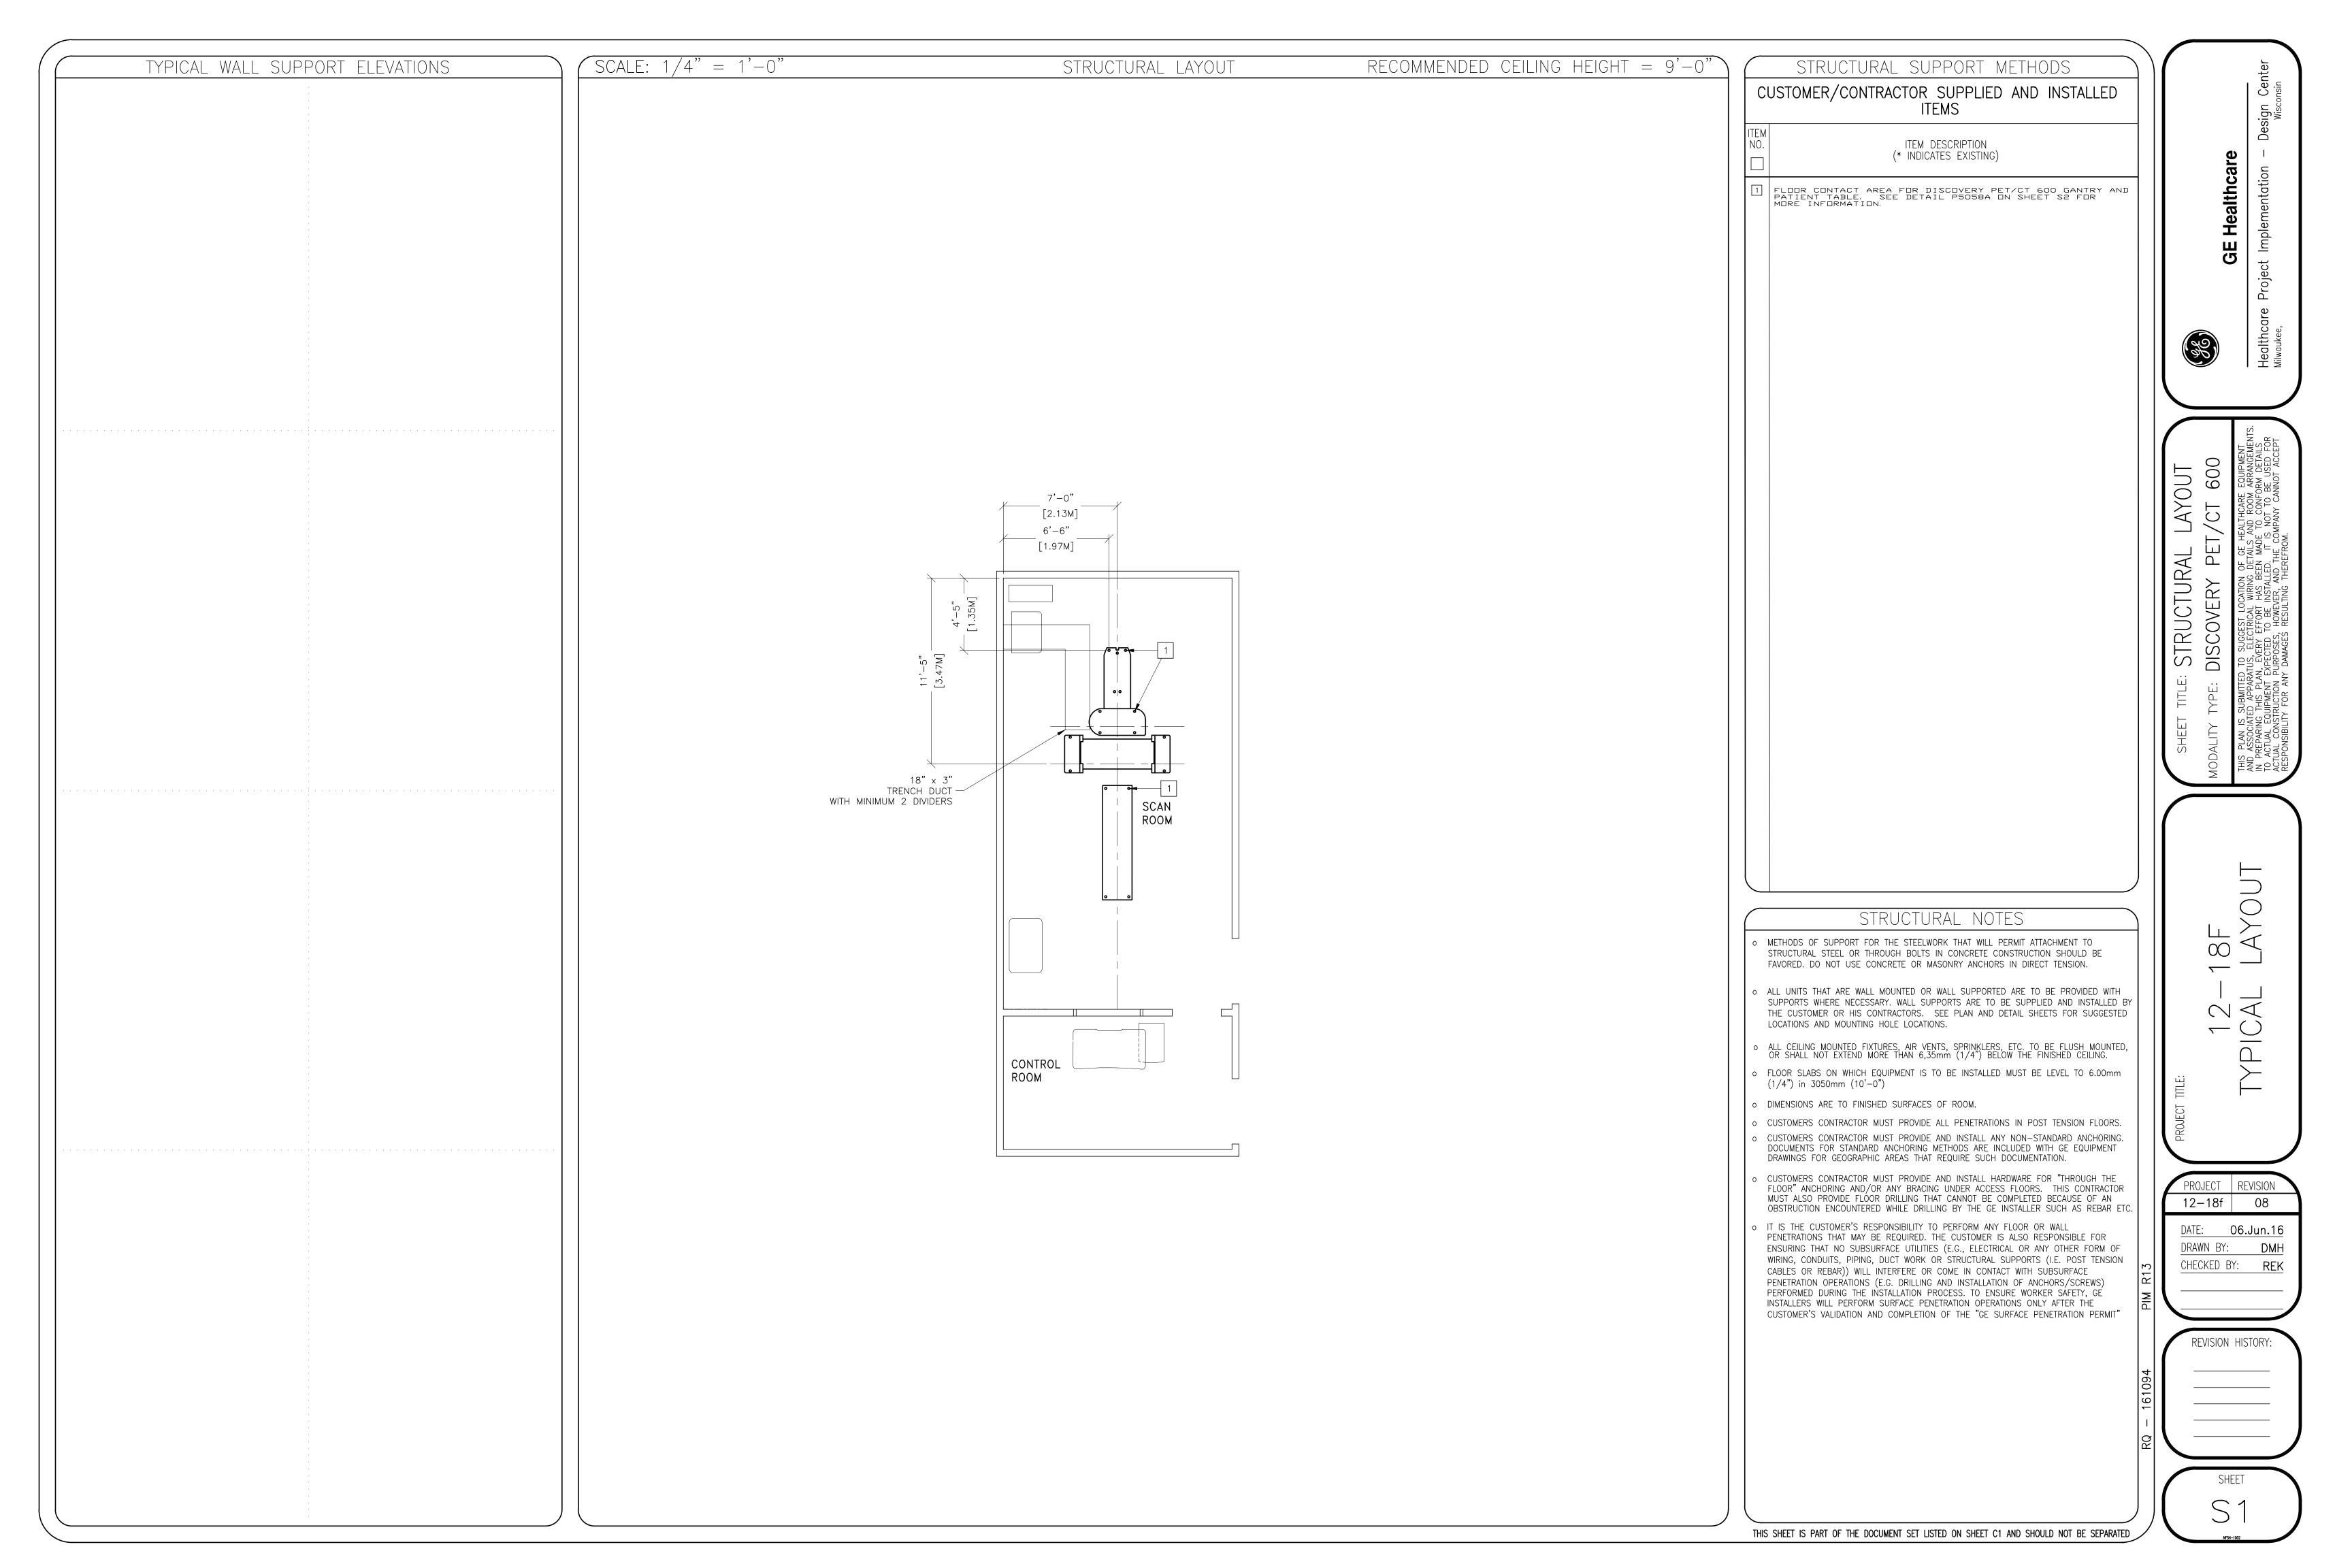
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JUNCTION POINT DESCRIPTIONS THE FOLLOWING MATERIALS ARE TO BE SUPPLIED AND O POINT INSTALLED BY THE CUSTOMER'S ELECTRICAL CONTRACTOR DESCRIPTION DETAIL NO., SHT. HARDWARE 90 AMP FUSED DISCONNECT AND MAGNETIC CONTACTOR MAIN DISCONNECT * AVAILABLE FROM GEHC, CALL: 800-279-7925 OR LOCAL GE INSTALLATION PROJECT MGR. GEMS CAT. NO. E4502AB 'SEO' PUSHBUTTON AND COVER INCLUDED TPT CT-PET 2 2 1/2 IN. DIA. BUSHING & LOCKNUT ELEC-25 3 3 IN. DIA. BUSHING & LOCKNUT SCANNER . DOOR SWITCH (NEEDED ONLY IF REQUIRED BY STATE/ LOCAL CODES) 1 ROOM DOOR INTERLOCK LIMIT SWITCH IN FRAME - NORMALLY OPEN (24V)
1 SINGLE GANG BOX OPERATORS CONSOLE 1 12 IN. OF GROMMET MATERIAL FOR A 3 X 3 IN. OPENING IN DUCT COVER ELEC-5 1 SPLIT COVERPLATE
1 12 IN. OF GROMMET MATERIAL FOR A
3 X 3 IN. OPENING IN DUCT COVER
4 2 IN. 90 DEGREE CONNECTOR
2 6 FT. LENGTH OF 2 IN. FLEXIBLE
METAL CONDUIT
2 SUITABLE CONNECTORS
1 12 X 16 X 4 IN. BOX
1 6 FT. LENGTH OF 1/2 IN. FLEXIBLE
METAL CONDUIT PARC PARC 1 SPLIT COVERPLATE
1 12 IN. OF GROMMET MATERIAL FOR A
3 X 3 IN. OPENING IN DUCT COVER
4 2 IN. 90 DEGREE CONNECTOR
2 6 FT. LENGTH OF 2 1/2 IN.
FLEXIBLE METAL CONDUIT
2 SUITABLE CONNECTORS
1 12 X 16 X 4 IN. BOX
1 6 FT. LENGTH OF 1/2 IN. FLEXIBLE
METAL CONDUIT PDU | POWER DISTRIBUTION UNIT 1 SINGLE GANG 2 1/2 IN. DEEP FLUSH MOUNTED JUNCTION BOX. SED | EMERGENCY OFF ELEC-16 UPS UPS CABINET 1 COVERPLATE ELEC-8 1 COVERPLATE
1 2 IN. DIA. CHASE NIPPLE
1 4 X 4 X 4 IN. BOX
2 IN. DIA. BUSHING & LOCKNUT
1 1 IN. DIA. CHASE NIPPLE
2 1 IN. DIA. BUSHING & LOCKNUT
(IF OPTIONAL 2 IN. CND IS
USED, ADD THE FOLLOWING)
1 4 X 4 X 4 IN BOX
1 COVERPLATE. COVERPLATE. 1 COVERPLATE
1 SINGLE GANG BOX
1 'X-RAY DN' INCANDESCENT LIGHT
FIXTURE - DD NOT USE FLUORESCENT
FIXTURES.
1 *E4502RL WARNING LIGHT
24V CONTROL OR EQUIVALENT. WARNING LIGHT 1 E4500AM WARNING LIGHT CONTROL OR EQUIVALENT MAX 24V CONTROLLER WARNING LIGHT CONTROLLER *AVAILABLE FROM ELEC-17 GEHC, CALL: 800-279-7925 DR LDCAL GE INSTALLATION PROJECT MGR. CONTRACTOR SUPPLIED AND INSTALLED WIRING

ELECTRICAL CONTRACTOR SHALL RING OUT AND TAG ALL WIRES AT BOTH ENDS. QUANTITY, WIRE SIZE/COLOR WIRE RUN, FROM - TO 1-NO.14 BLACK, 1-NO.14 WHITE, 1-NO.14 GREEN 3 BLACK, 1 WHITE, 1 GREEN - REFER TO FEEDER TABLE 3-BLACK, 1 GREEN - REFER TO FEEDER TABLE 1-ND. 14 BLACK, 1-ND. 14 WHITE, 1-ND. 14 GREEN WLC > 1 PHASE 1-NO. 14 BLACK, 1-NO. 14 WHITE, 1-NO. 14 GREEN 2-NO. 14 BLACK, 1-NO. 14 RED, 1-NO. 14 WHITE 1-NO. 14 BLACK, 1-NO. 14 WHITE, 1-NO. 14 GREEN

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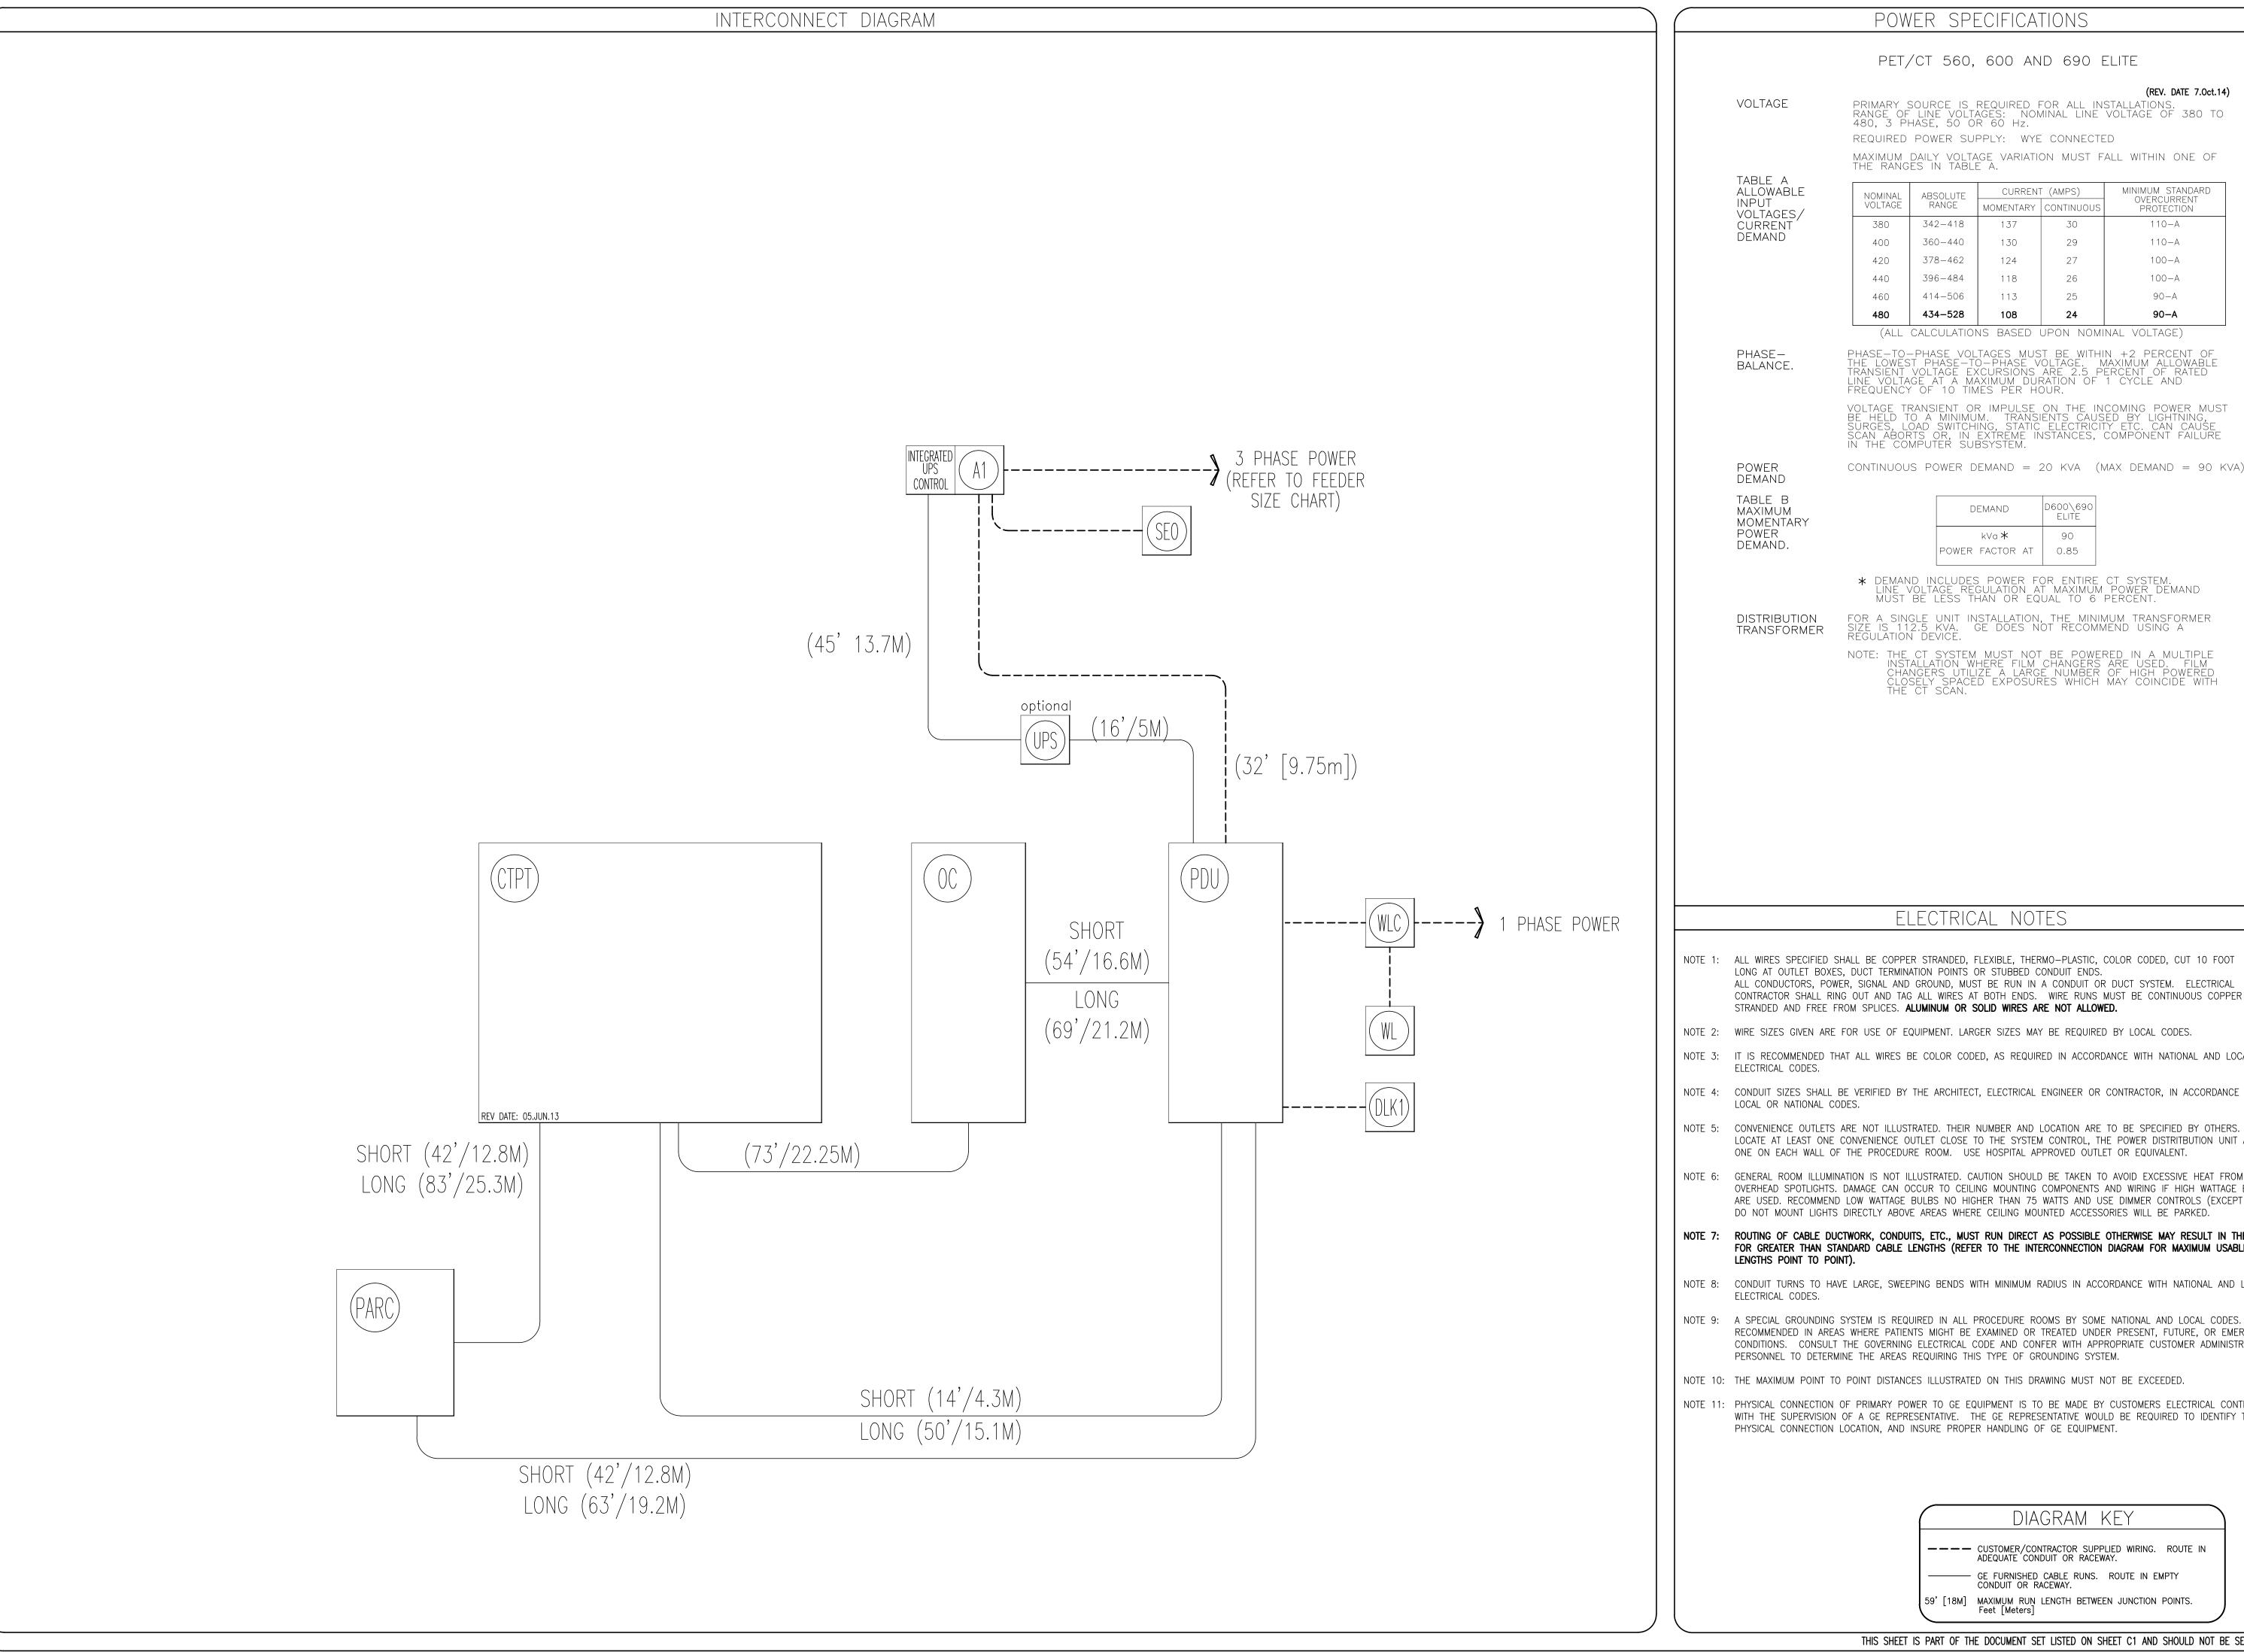
009 LAYOUT CT ELECTRICA DISCOVERY ECTRIC/ GEST LOCATIC CTRICAL WIRII EFFORT HAS TO BE INST, HOWEVER, S, HOWEVER,

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POWER SPECIFICATIONS

PET/CT 560, 600 AND 690 ELITE

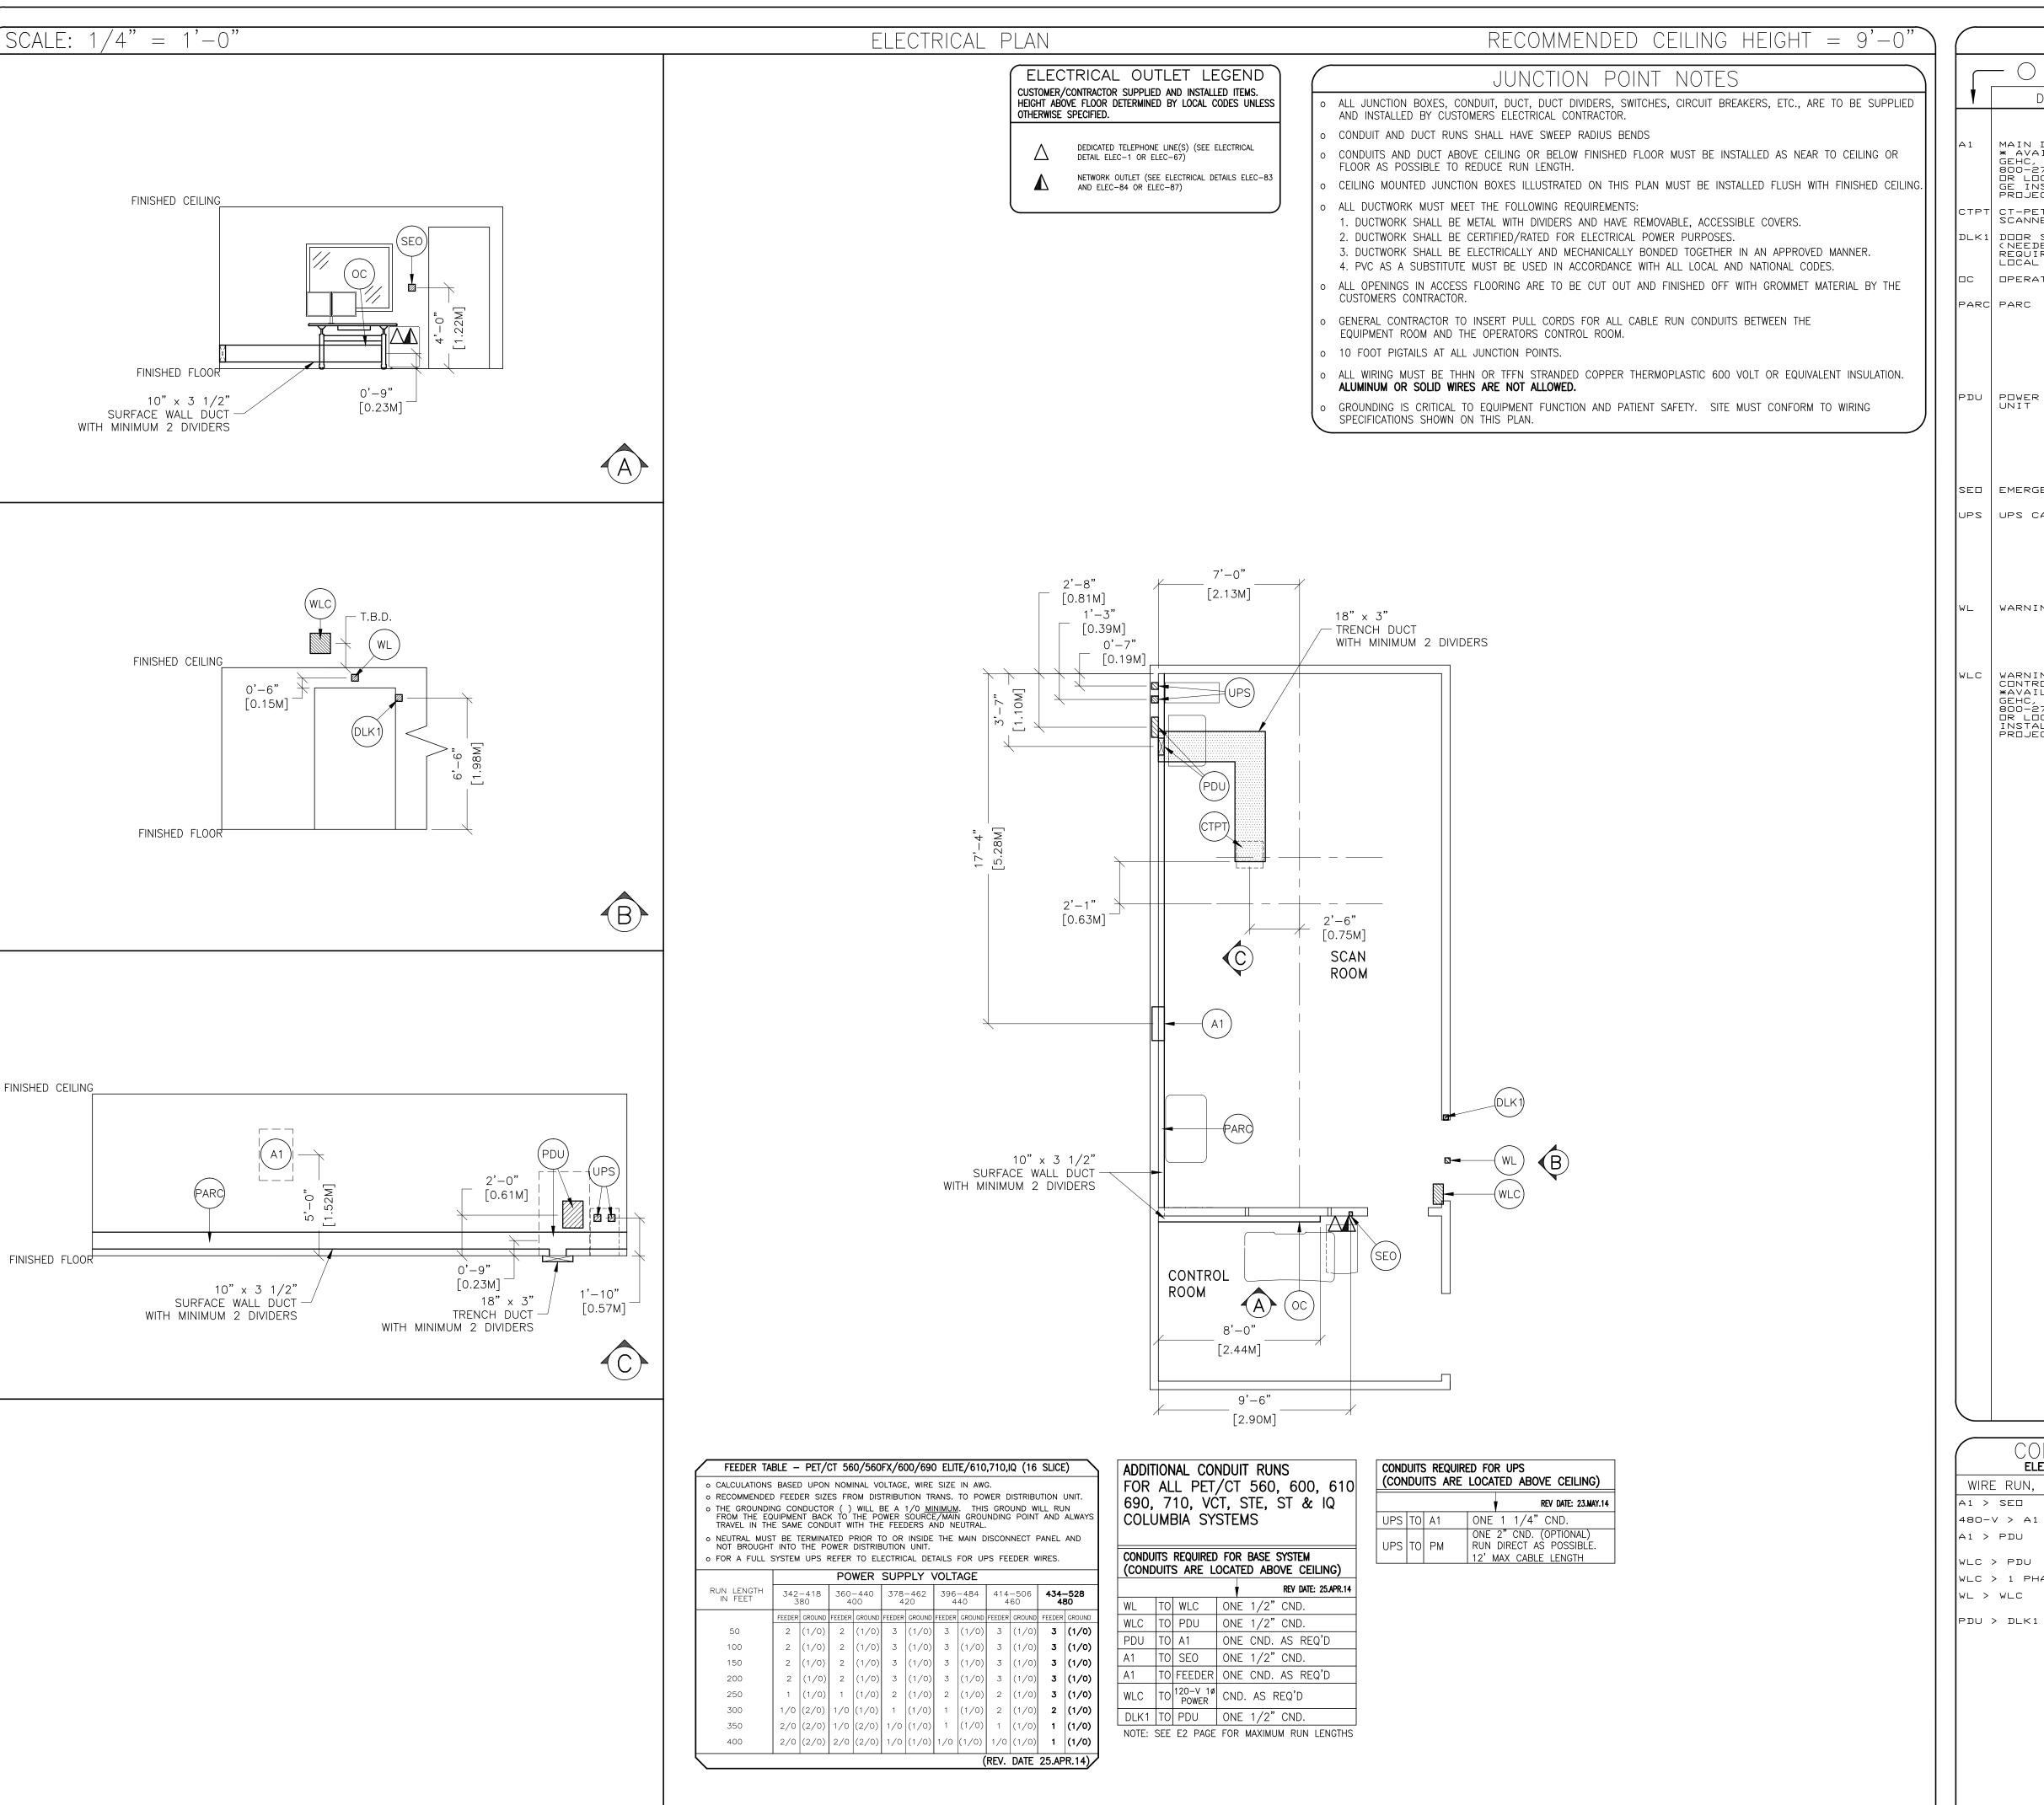(REV. DATE 7.0ct.14) PRIMARY SOURCE IS REQUIRED FOR ALL INSTALLATIONS.
RANGE OF LINE VOLTAGES: NOMINAL LINE VOLTAGE OF 380 TO
480, 3 PHASE, 50 OR 60 Hz.

REQUIRED POWER SUPPLY: WYE CONNECTED

MAXIMUM DAILY VOLTAGE VARIATION MUST FALL WITHIN ONE OF THE RANGES IN TABLE A.

| NOMINAI | ABSOLUTE | CURREN | (AMPS) | MINIMUM STANDARD |
|---------|----------|-----------|------------|---------------------------|
| VOLTAGE | RANGE | MOMENTARY | CONTINUOUS | OVERCURRENT PROTECTION |
| 380 | 342-418 | 137 | 30 | 110-A |
| 400 | 360-440 | 130 | 29 | 110-A |
| 420 | 378-462 | 124 | 27 | 100-A |
| 440 | 396-484 | 118 | 26 | 100-A |
| 460 | 414-506 | 113 | 25 | 90-A |
| 480 | 434-528 | 108 | 24 | 90 – A |

(ALL CALCULATIONS BASED UPON NOMINAL VOLTAGE)

PHASE—TO—PHASE VOLTAGES MUST BE WITHIN +2 PERCENT OF THE LOWEST PHASE—TO—PHASE VOLTAGE. MAXIMUM ALLOWABLE TRANSIENT VOLTAGE EXCURSIONS ARE 2.5 PERCENT OF RATED LINE VOLTAGE AT A MAXIMUM DURATION OF 1 CYCLE AND FREQUENCY OF 10 TIMES PER HOUR.

VOLTAGE TRANSIENT OR IMPULSE ON THE INCOMING POWER MUST BE HELD TO A MINIMUM. TRANSIENTS CAUSED BY LIGHTNING, SURGES, LOAD SWITCHING, STATIC ELECTRICITY ETC. CAN CAUSE SCAN ABORTS OR, IN EXTREME INSTANCES, COMPONENT FAILURE IN THE COMPUTER SUBSYSTEM.

CONTINUOUS POWER DEMAND = 20 KVA (MAX DEMAND = 90 KVA)

DEMAND TABLE B

D600\690 DEMAND ELIŤE kVa 🛠 90 POWER FACTOR AT | 0.85

* DEMAND INCLUDES POWER FOR ENTIRE CT SYSTEM. Line voltage regulation at maximum power demand must be less than or equal to 6 percent.

DISTRIBUTION

FOR A SINGLE UNIT INSTALLATION, THE MINIMUM TRANSFORMER SIZE IS 112.5 KVA. GE DOES NOT RECOMMEND USING A REGULATION DEVICE.

THE CT SYSTEM MUST NOT BE POWERED IN A MULTIPLE INSTALLATION WHERE FILM CHANGERS ARE USED. FILM CHANGERS UTILIZE A LARGE NUMBER OF HIGH POWERED CLOSELY SPACED EXPOSURES WHICH MAY COINCIDE WITH THE CT SCAN.

ELECTRICAL NOTES

- NOTE 1: ALL WIRES SPECIFIED SHALL BE COPPER STRANDED, FLEXIBLE, THERMO-PLASTIC, COLOR CODED, CUT 10 FOOT LONG AT OUTLET BOXES, DUCT TERMINATION POINTS OR STUBBED CONDUIT ENDS. ALL CONDUCTORS, POWER, SIGNAL AND GROUND, MUST BE RUN IN A CONDUIT OR DUCT SYSTEM. ELECTRICAL CONTRACTOR SHALL RING OUT AND TAG ALL WIRES AT BOTH ENDS. WIRE RUNS MUST BE CONTINUOUS COPPER STRANDED AND FREE FROM SPLICES. ALUMINUM OR SOLID WIRES ARE NOT ALLOWED.
- NOTE 2: WIRE SIZES GIVEN ARE FOR USE OF EQUIPMENT. LARGER SIZES MAY BE REQUIRED BY LOCAL CODES.
- NOTE 3: IT IS RECOMMENDED THAT ALL WIRES BE COLOR CODED, AS REQUIRED IN ACCORDANCE WITH NATIONAL AND LOCAL ELECTRICAL CODES.
- NOTE 4: CONDUIT SIZES SHALL BE VERIFIED BY THE ARCHITECT, ELECTRICAL ENGINEER OR CONTRACTOR, IN ACCORDANCE WITH LOCAL OR NATIONAL CODES.
- LOCATE AT LEAST ONE CONVENIENCE OUTLET CLOSE TO THE SYSTEM CONTROL, THE POWER DISTRITBUTION UNIT AND ONE ON EACH WALL OF THE PROCEDURE ROOM. USE HOSPITAL APPROVED OUTLET OR EQUIVALENT.
- NOTE 6: GENERAL ROOM ILLUMINATION IS NOT ILLUSTRATED. CAUTION SHOULD BE TAKEN TO AVOID EXCESSIVE HEAT FROM OVERHEAD SPOTLIGHTS. DAMAGE CAN OCCUR TO CEILING MOUNTING COMPONENTS AND WIRING IF HIGH WATTAGE BULBS ARE USED. RECOMMEND LOW WATTAGE BULBS NO HIGHER THAN 75 WATTS AND USE DIMMER CONTROLS (EXCEPT MR). DO NOT MOUNT LIGHTS DIRECTLY ABOVE AREAS WHERE CEILING MOUNTED ACCESSORIES WILL BE PARKED.
- NOTE 7: ROUTING OF CABLE DUCTWORK, CONDUITS, ETC., MUST RUN DIRECT AS POSSIBLE OTHERWISE MAY RESULT IN THE NEED FOR GREATER THAN STANDARD CABLE LENGTHS (REFER TO THE INTERCONNECTION DIAGRAM FOR MAXIMUM USABLE LENGTHS POINT TO POINT).
- NOTE 8: CONDUIT TURNS TO HAVE LARGE, SWEEPING BENDS WITH MINIMUM RADIUS IN ACCORDANCE WITH NATIONAL AND LOCAL ELECTRICAL CODES.
- NOTE 9: A SPECIAL GROUNDING SYSTEM IS REQUIRED IN ALL PROCEDURE ROOMS BY SOME NATIONAL AND LOCAL CODES. IT IS RECOMMENDED IN AREAS WHERE PATIENTS MIGHT BE EXAMINED OR TREATED UNDER PRESENT, FUTURE, OR EMERGENCY CONDITIONS. CONSULT THE GOVERNING ELECTRICAL CODE AND CONFER WITH APPROPRIATE CUSTOMER ADMINISTRATIVE PERSONNEL TO DETERMINE THE AREAS REQUIRING THIS TYPE OF GROUNDING SYSTEM.
- NOTE 10: THE MAXIMUM POINT TO POINT DISTANCES ILLUSTRATED ON THIS DRAWING MUST NOT BE EXCEEDED.
- NOTE 11: PHYSICAL CONNECTION OF PRIMARY POWER TO GE EQUIPMENT IS TO BE MADE BY CUSTOMERS ELECTRICAL CONTRACTOR WITH THE SUPERVISION OF A GE REPRESENTATIVE. THE GE REPRESENTATIVE WOULD BE REQUIRED TO IDENTIFY THE PHYSICAL CONNECTION LOCATION, AND INSURE PROPER HANDLING OF GE EQUIPMENT.

DIAGRAM KEY

---- CUSTOMER/CONTRACTOR SUPPLIED WIRING. ROUTE IN ADEQUATE CONDUIT OR RACEWAY. GE FURNISHED CABLE RUNS. ROUTE IN EMPTY CONDUIT OR RACEWAY.

59' [18M] MAXIMUM RUN LENGTH BETWEEN JUNCTION POINTS.

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SPECIFICATIONS PET/CT 600

ELECTRICAL


DISCOVERY


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PROJECT | REVISION 12-18f 08 DATE: 06.Jun.16


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ELECTRICAL DETAIL




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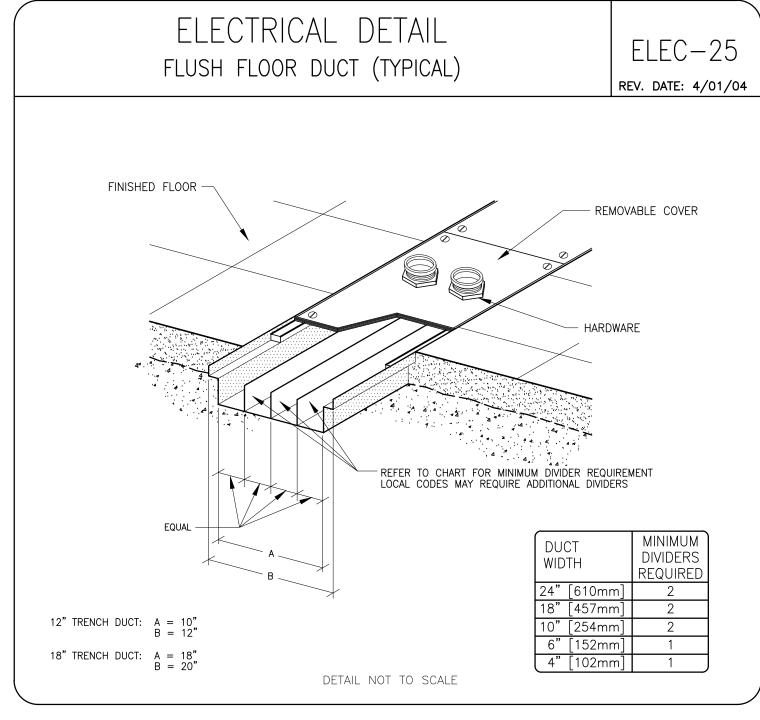
ELEC-22

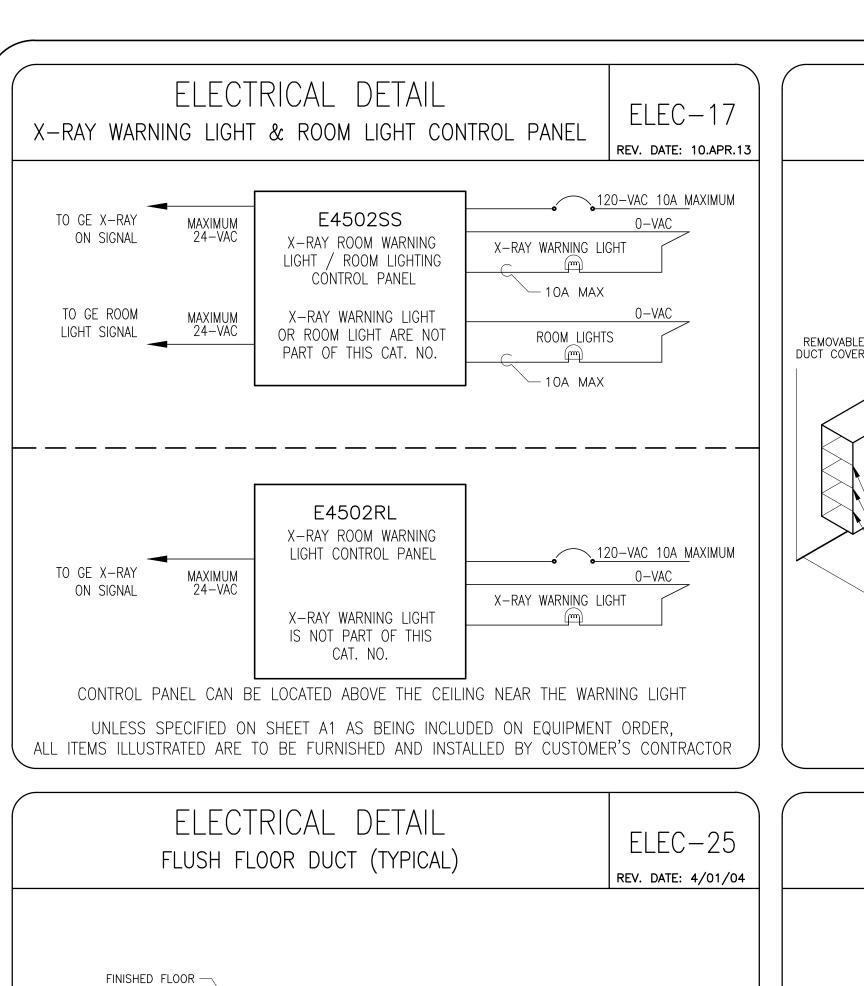
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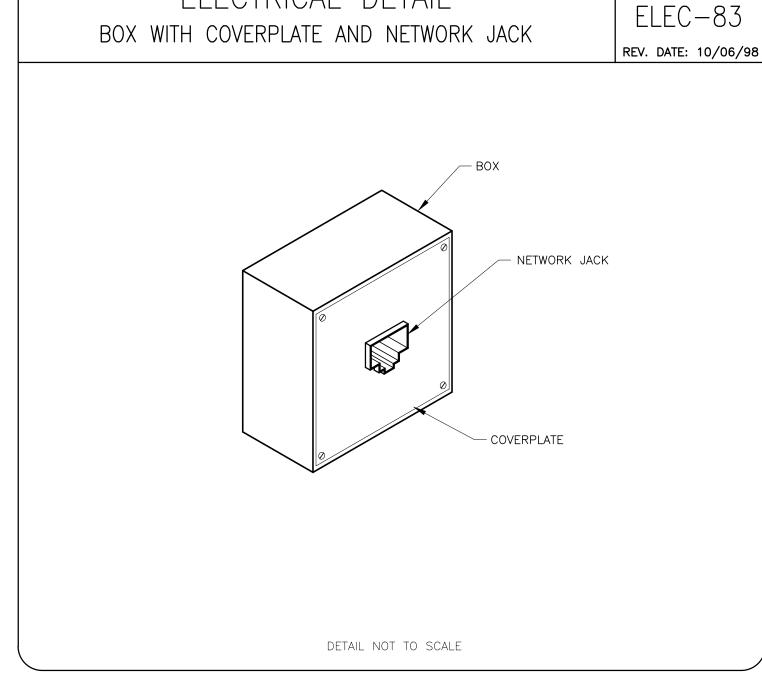
ELECTRICAL DETAIL

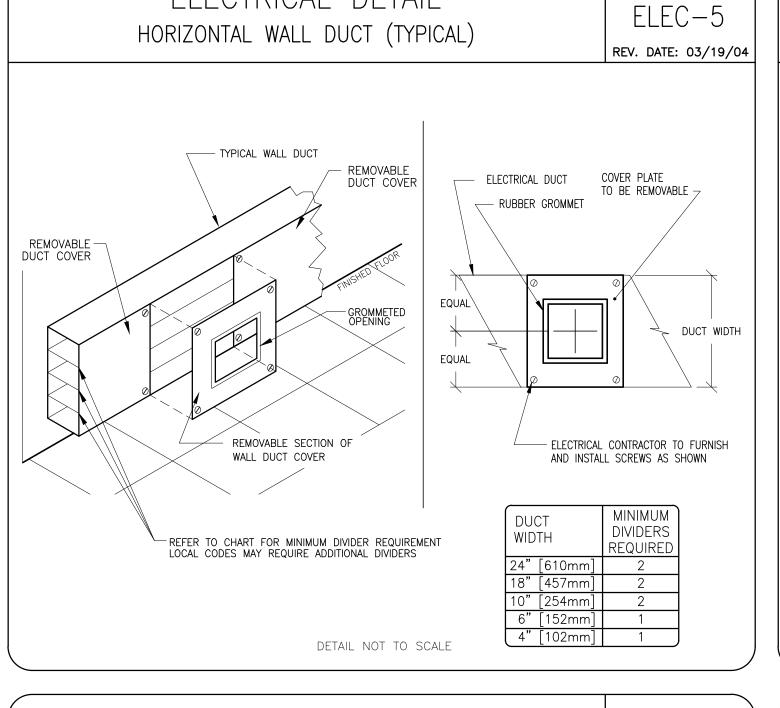
BOX WITH SPLIT COVERPLATE (TYPICAL)

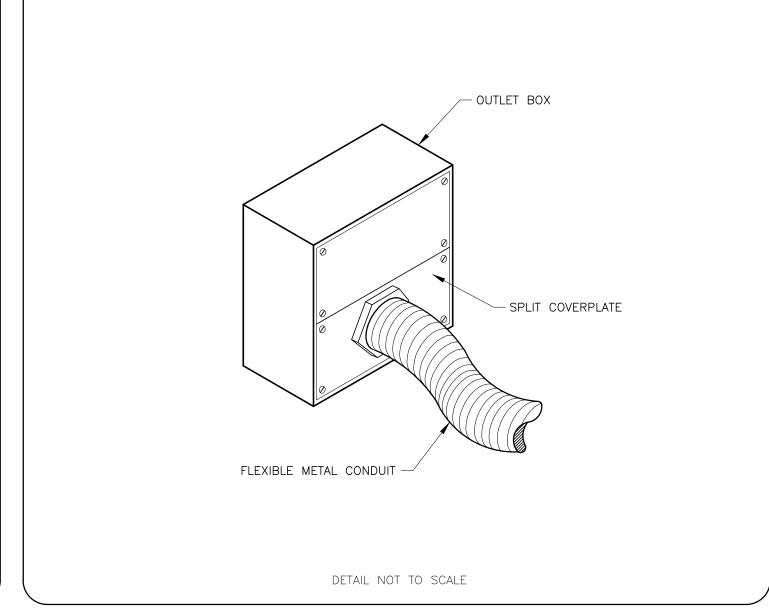





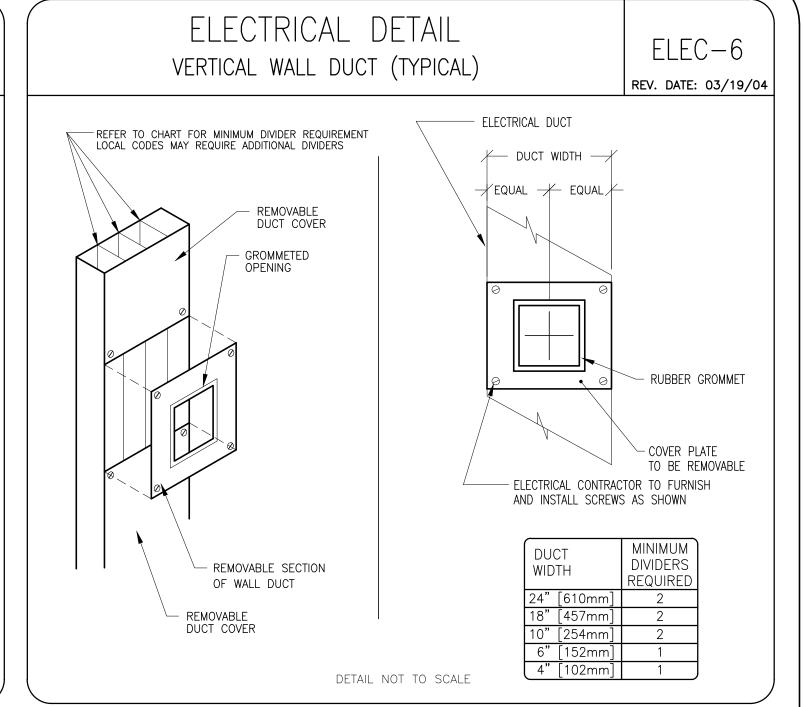


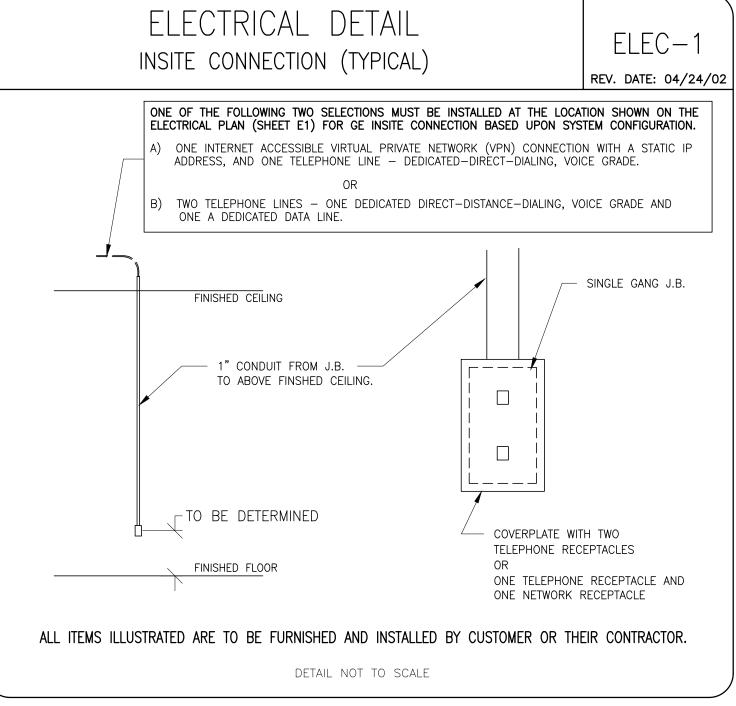

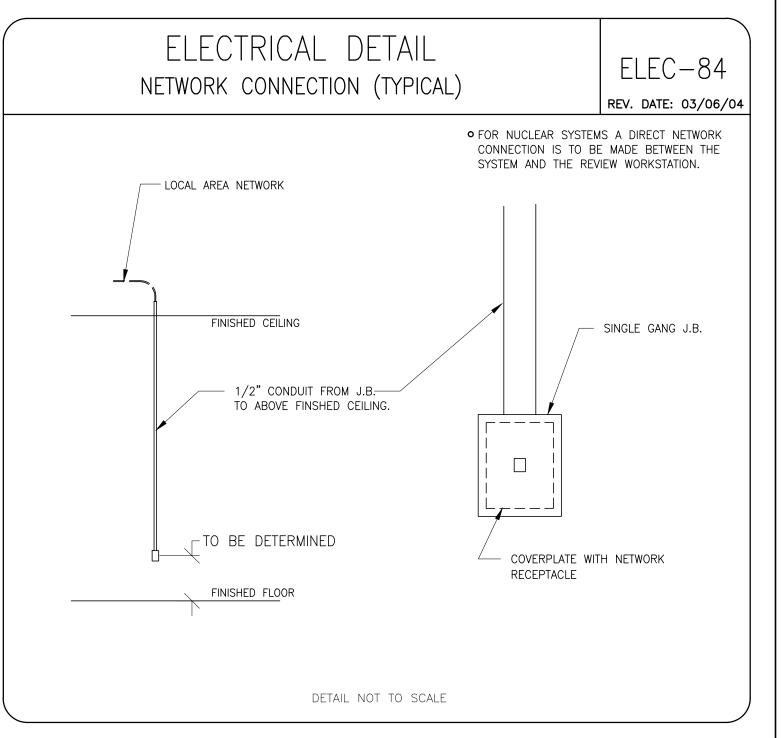

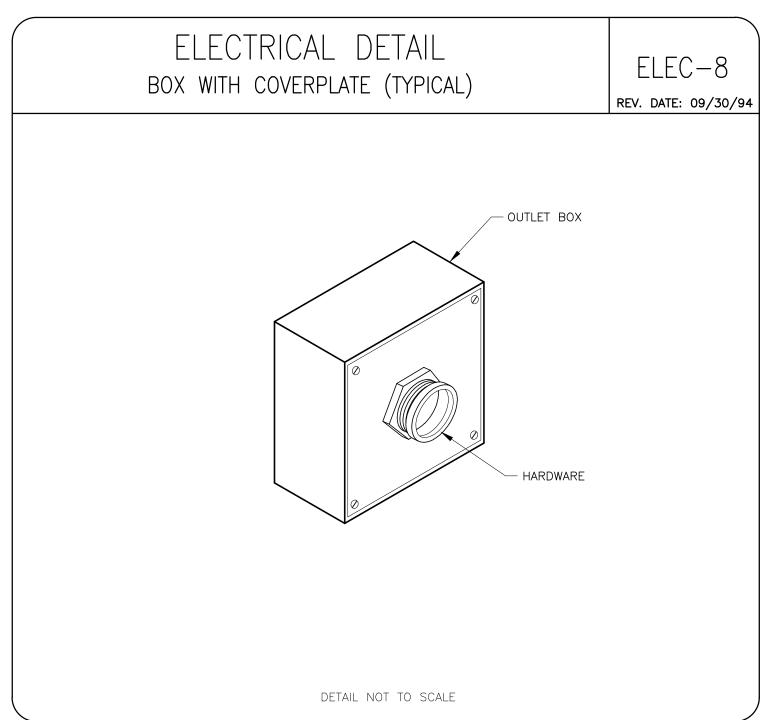

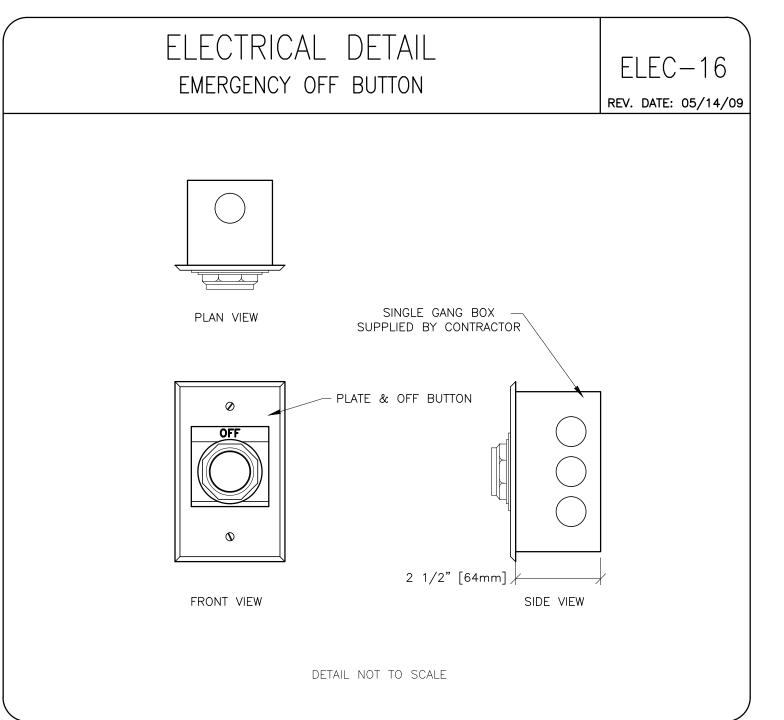

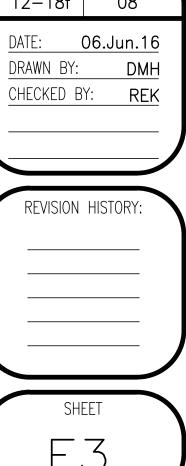

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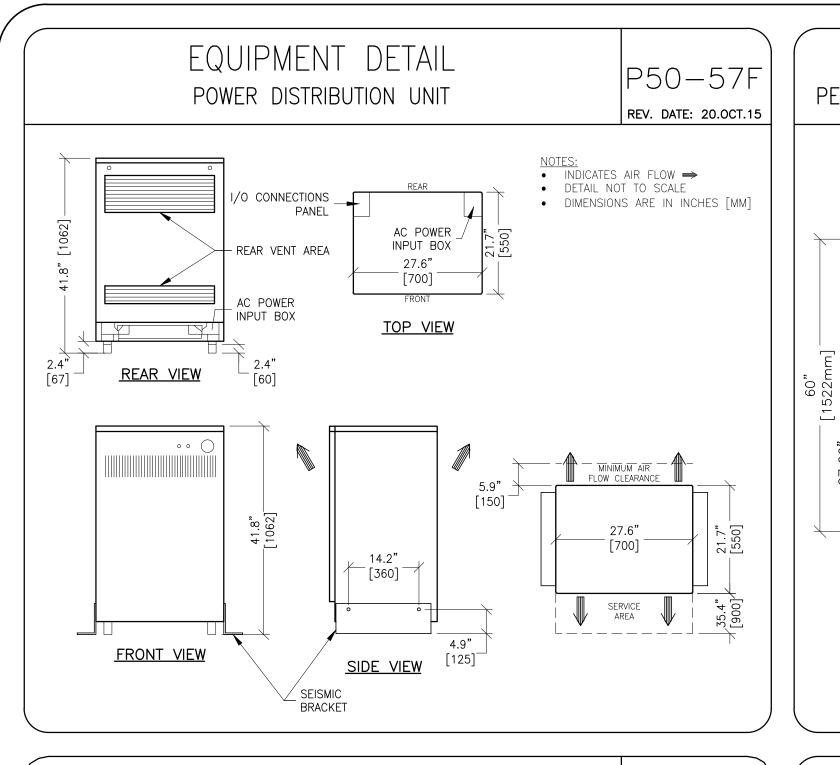
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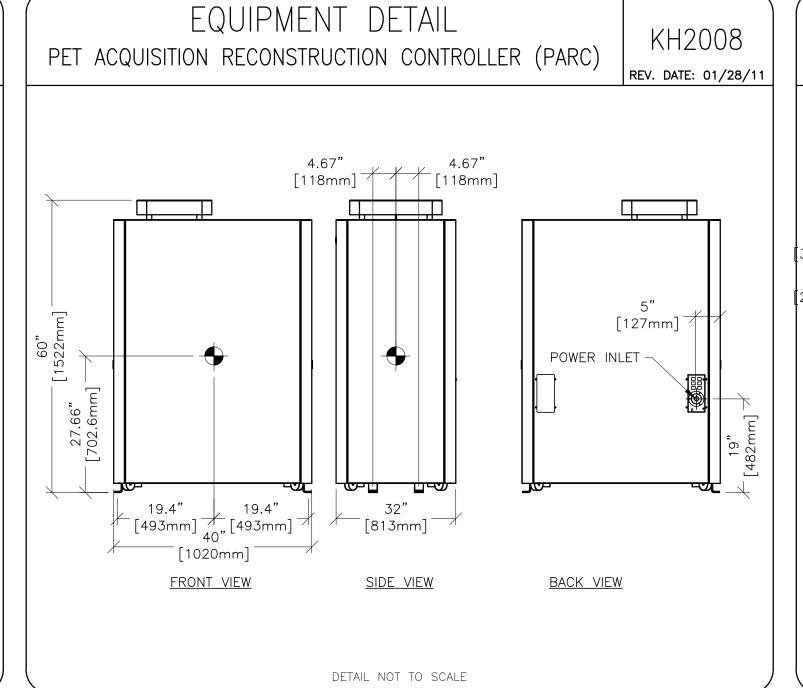
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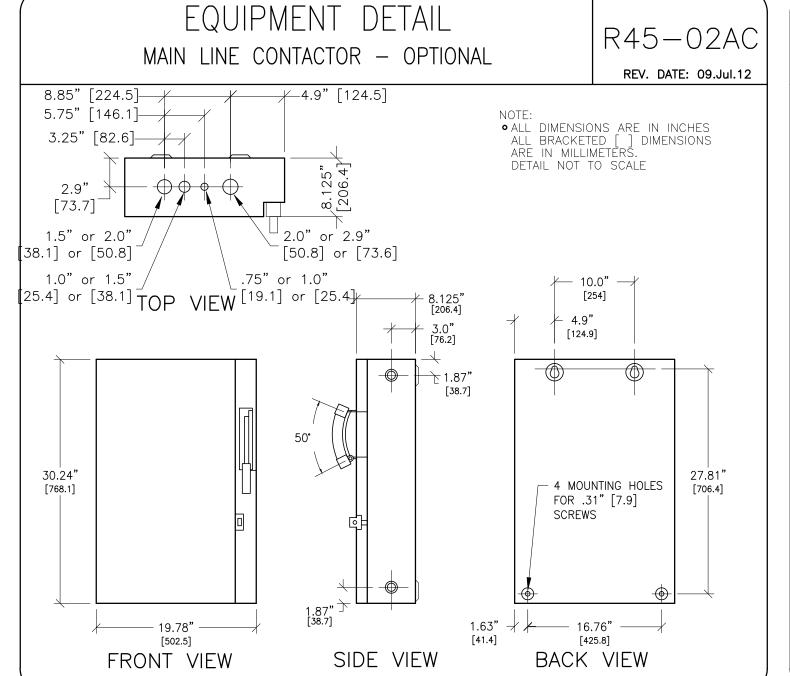
DETAILS


ELECTRICAL DISCOVERY PE


PROJECT 12-18f DRAWN BY: CHECKED BY:








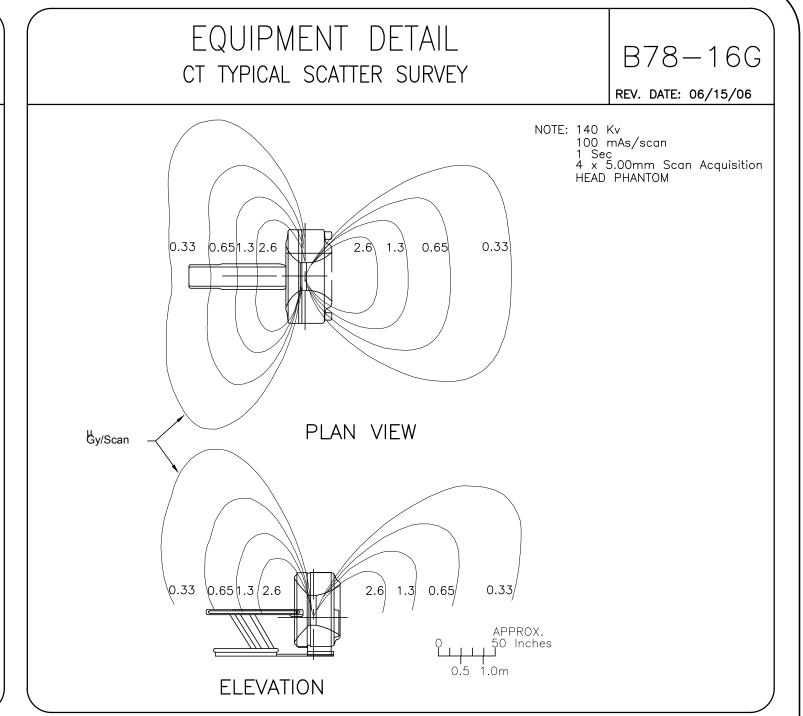

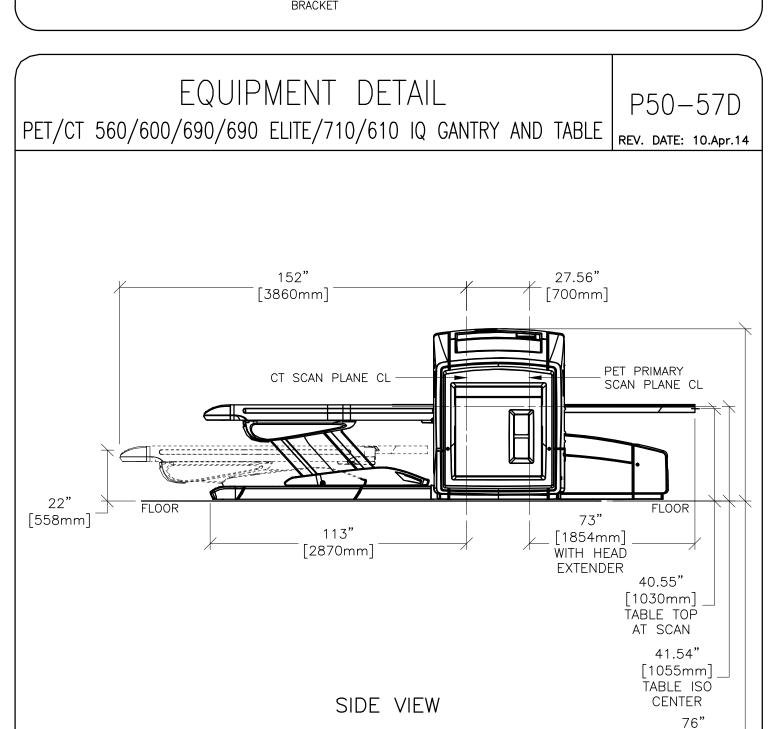

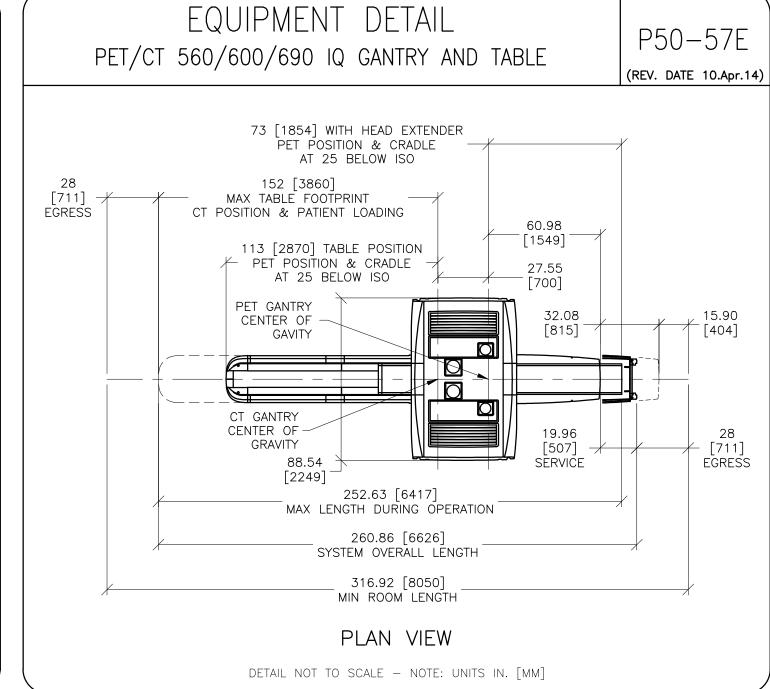

| ITEM | LENGTH IN. [MM] | WIDTH IN. [MM] | HEIGHT IN. [MM] | WEIGHT lb [kg] | LIFTABLE (OPTIONAL) | RIGGERS TO MOVE | CONSTRUCTION PACKAGE (OPTIONAL) |
|-------------------------------|--------------------|-------------------|--------------------|-------------------|------------------------|--------------------|---------------------------------|
| 600/690 ELITE CT GANTRY | 114 [2896] | 51 [1295] | 77 [1955] | 4187 [1899] | YES | YES | YES |
| 690 VCT CT GANTRY | 114 [2896] | 51 [1295] | 77 [1955] | 4260 [1932] | YES | YES | YES |
| PET SOURCE RING AND TRAILER | 96 [2438] | 44 [1118] | 43 [1092] | 1340 [608] | YES | YES | YES |
| PET IMAGE RING | 110 [2794] | 44 [1118] | 74 [1880] | 3205 [1454] | YES | YES | YES |
| PET RETRACTOR & BASE ASSEMBLY | 96 [2438] | 41.5 [1050] | 39 [990] | 1495 [678] | YES | YES | YES |
| PARC | 32 [816] | 40 [1020] | 60 [1522] | 900 [408] | YES | YES | YES |
| TABLE WITH ACCESSORIES | 161 [4089] | 34 [864] | 55.5 [1410] | 2856 [1295] | YES | YES | YES |
| POWER DISTRIBUTION UNIT | 30 [762] | 23 [584] | 43 [1092] | 910 [413] | YES | YES | YES |
| SKID WITH CONSOLE | 54 [1372] | 46 [1168] | 43 [1092] | 560 [254] | YES | YES | YES |

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REV. DATE: 01/28/11

EQUIPMENT DETAIL


EQUIPMENT SHIPPING DETAIL


| | * FI | LOOR PROTECTION F | REQUIRED | |
|--|--------------------|-------------------|---------------------|------------------|
| CONFIGURATION | LENGTH - IN. [MM] | WIDTH - IN. [MM] | HEIGHT — IN. [MM] | WEIGHT — lb [kg] |
| DOLLIES ON, SIDE RAILS ON | 114 [2896] | 51 [1295] | 77 [1955] | 4260 [1932]* |
| DOLLIES ON, SIDE RAILS REMOVED | 114 [2896] | 42 [1067] | 77 [1955] | 4220 [1914] |
| PET BASE & RETRACTOR ASSEMBLY | 96 [2438] | 41.5 [1050] | 39 [990] | 1495 [698] |
| PET IMAGE RING WITH DOLLIES | 110 [2794] | 44 [1118] | 74 [1880] | 3205 [1454] |
| PET SOURCE RING AND TRAILER WITH DOLLIES | 96 [2438] | 44 [1118] | 43 [1092] | 1340 [608] |
| BLUE DOLLIES ON, RED CASTORS ON | 120 [3048] | 40 [1016] | 55.5 [1410] NOMINAL | 2856 [1295] |
| BLUE DOLLIES ON | 151 [3836] | 34 [864] | 55.5 [1410] NOMINAL | 2736 [1241] |
| TILTING | 98-115 [2489-2921] | 26 [660] | 70-80 [1778-2032] | 100 [636] |


EQUIPMENT DETAIL

EQUIPMENT SHIPPING DETAIL

| | B6090C rev. date: 08/11/ | | | |
|------------------------------------|-----------------------------|------------------|-------------------|------------------|
| CONFIGURATION | LENGTH — IN. [MM] | WIDTH — IN. [MM] | HEIGHT — IN. [MM] | WEIGHT — Ib [kg] |
| PARC SHIPPING CRATE | 32 [181] | 50 [127] | 60 [170] | 900 [408] |
| SKID WITH OPERATORS CONSOLE | 54 [1372] | 46 [1168] | 43 [1092] | 560 [254] |
| SKID WITH CONSOLE COMPONENTS | 40 [1016] | 40 [1016] | 33 [838] | 120 [54] |

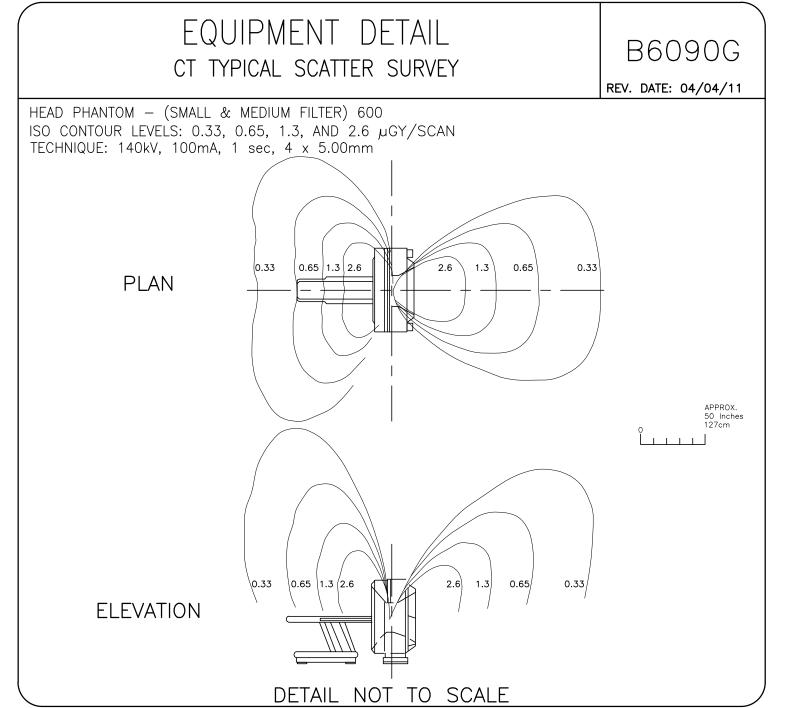

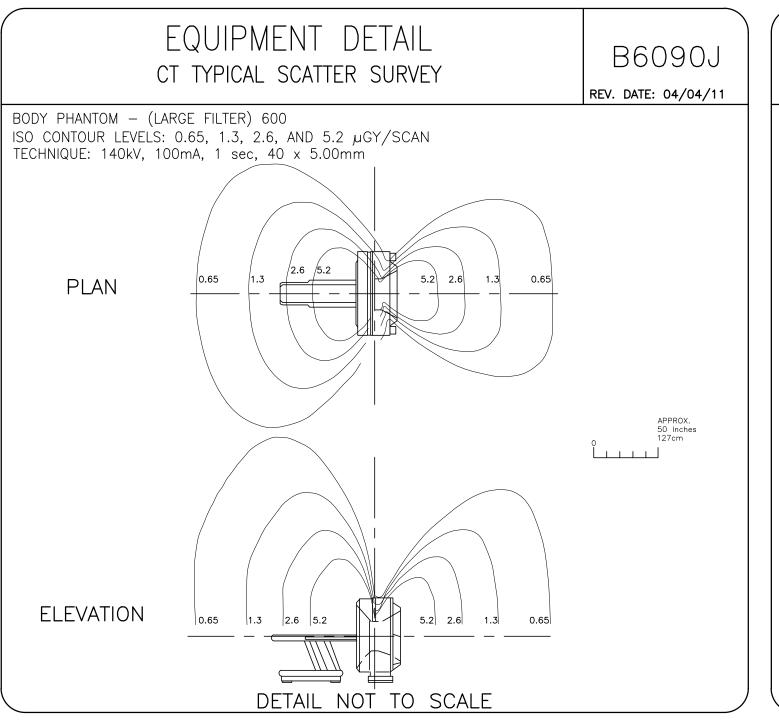

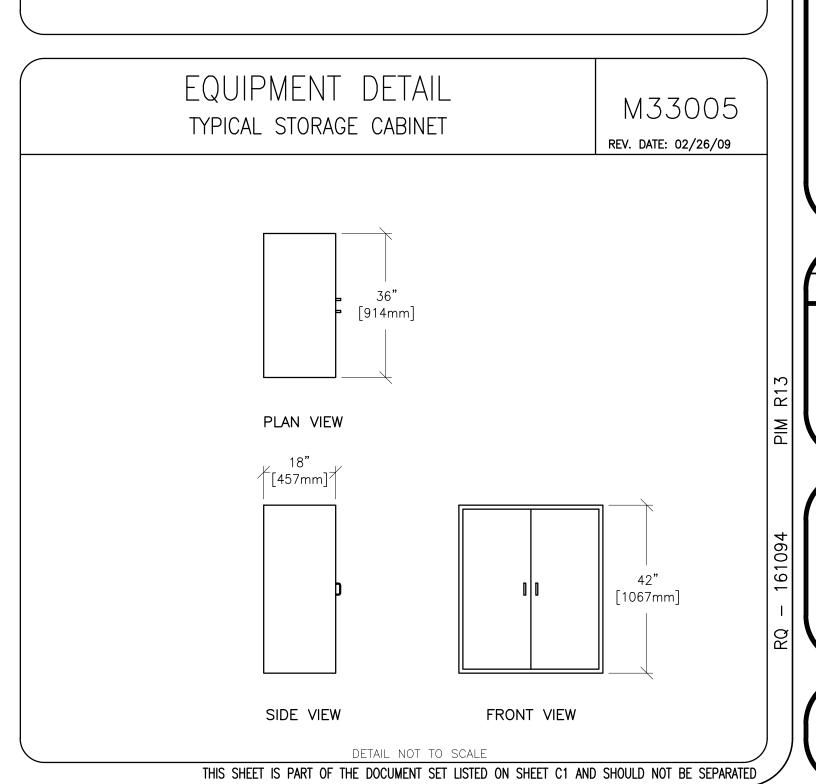

 ∞ \sim \leftarrow PROJECT 80 06.Jun.16 REVISION HISTORY

Healthcare 96 99

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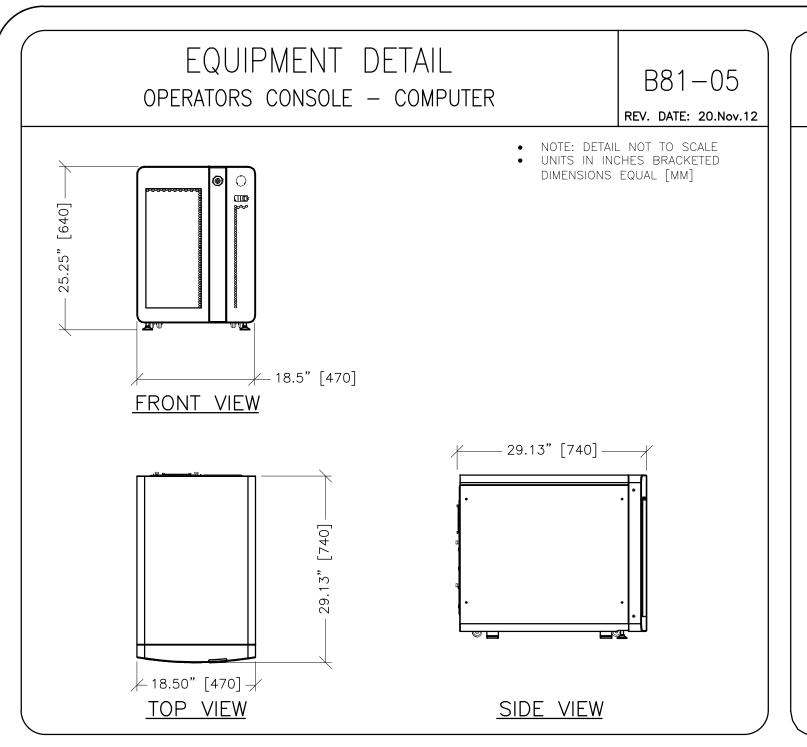
sign Wisco


600 600 **DETAIL**§ EQUIPMENT DISCOVERY PE O TO SUGGEST LOCATION OF GATUS, ELECTRICAL WIRING DETAIN, EVERY EFFORT HAS BEEN MEXPECTED TO BE INSTALLED. PURPOSES, HOWEVER, AND THE DAMAGES RESULTING THEREFT


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REV. DATE: 01/28/11

12-18f DRAWN BY: CHECKED BY:





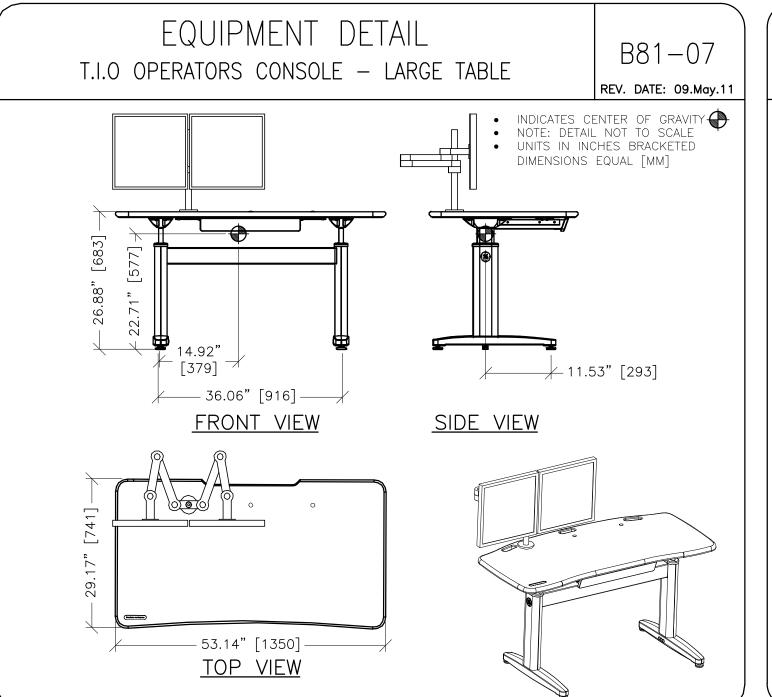

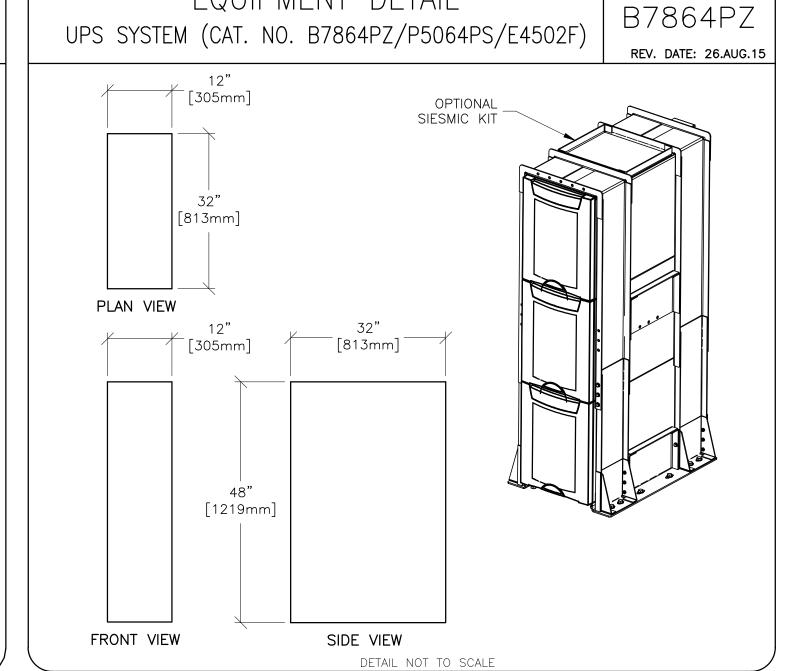EQUIPMENT DETAIL

SHEET TITLE: EQUIPMENT DETAILS HODALITY TYPE: DISCOVERY PET/CT 600

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GE Healthcare

96

12—18F TYPICAL LAYOUT

PROJECT REVISION

12-18f 08

DATE: 06.Jun.16

DRAWN BY: DMH

CHECKED BY: REK

REVISION HISTORY:

SHEET